A-FRAME: ALL WELDING TO BE MIG ALL WELDING TO BE PREFORMED BY CERTIFIED WELDERS TYPE: **PERIMETER** MAIN BEAM: C15"x33.9# CHANNEL (ROLLED) X-MEMBER: 3 C10 X 15.3# @ 24" O.C. 2x3x3/16" STRINGERS MISC: 10 6x3x1/4 ANGLE AT STAIR LOCATIONS MISC: 11 MISC: 12 GA FORMED ANGLE @ FLOOR OPENINGS 12 13 MISC: **EXPORT LASHING RINGS** MISC: (4) REMOVABLE LIFTING EYES FABRICATED FROM 5/8" PLATE STEEL 14 AND SECURED WITH (8) GRADE 8 BOLTS EACH ALL LOWER FRAME PARTS WIPED CLEAN AND PRIMED WITH PPG MULTI PRIME. 15 MISC: **EXPOSED PERIMETER FINAL PAINTED** MODULES DESIGNED FOR DROP DECK TRANSPORT, NO TOWING DEVICES ARE INCLUDED **B-FLOOR:** 4" ICYNENE PRO SEAL SPRAY FOAM INSULATION, R-28.4 **DECKING:** 1/4" STEEL DIAMOND PLATE WELDED TO FRAME PPG PAINT AND PRIMER FLOOR OPENINGS PER SPEC **C-EXTERIOR WALLS:** 2" x 4" x 16-GA. CSW GALVANIZED STEEL STUD @ 16" O.C. STUDS: **BOTTOM PLATE:** 2 3 5/8" x 3" LEG x 16-GA. STEEL TRACK TOP PLATE: 3 3 5/8" x 3" LEG x 16-GA. STEEL TRACK SIDEWALL HT: 10'-0" LOW SIDE: STUD LENGTH: 119.750 In. SIDEWALL HT: 10'- 3 1/2" HIGH SIDE; STUD LENGTH: 123.250 In. **ENDWALL HT:** 10'-0" LOW SIDE TO 10'-3 1/2" HIGH SIDE; STUD LENGTH: VARIES w/DBL. STUDS EACH END OF SIDEWALLS (SPF #3). DBL. 2"x 4" BOX HEADER, w/ TRACK, @ OPENINGS 38"W & LESS MIN 18GA DBL. 2"x 6" BOX HEADER, w/ TRACK, @ OPENINGS OVER 38" MIN 18GA DBL. JACKSTUD UNDER DOOR HEADERS: NOTE: ALL WALL OPENINGS LINED w/ FIRE-RETARDANT-TREATED 2x LUMBER **COVERING:** 5/8" MOISTURE-RESISTANT GYPSUM BOARD w/ .090" FRP **BONDED TO INTERIOR FACE** MATCHING FRP MOLDINGS @ PANEL SEAMS AND CORNERS FRP COLOR: MEDIUM GRAY FRP, TO MATCH WALL COVERING @ CORNERS AND SEAMS TRIM: 4a 1/2" NON-COMBUSTIBLE CDX SHEATHING (RATED 32/16) SHEATHING: 5 STAGGER SHEATHING SEAMS FROM INT. WALL COVERING NOTE: SEAMS--SIDEWALLS ONLY. AIR INFILTRATION BARRIER (TYVEK OR EQUAL) SHEATHING: 5a 3 1/2" (ONE-PASS) ICYNENE PROSEAL CLOSED CELL FOAM, R-25 INSULATION: 6 IN STUD BAYS. 7 SIDING: 26 GA. STEEL NIFF TONE RAISED VERT. RIB SIDING w/ EXPOSED FASTENERS NOTE: FLAT STEEL INSTALLED ABOVE DOORS & LOUVERS FOR CANOPY MOUNTING MAIN COLOR: LIGHT STONE TRIM: 26 GA. STEEL NIFF TONE 8

MATCH SIDING

CANOPY COVERING TO MATCH BUILDING

AT SINGLE DOOR, 84"W x 30"D. AT DOUBLE DOOR

SHIP LOOSE CANOPIES FOR ABOVE EXTERIOR DOORS, 48"W x 30"D.

SHIP LOOSE CANOPIES FOR ABOVE AIR INTAKE LOUVER & EXH FAN;

10 11

D-INTERIOR WALLS: NONE E-ROOF: RAFTERS: 8" 12 GA FORMED RAFTERS SPACED 16" O.C. FOR #30 LIVE LOAD & EQUIP LOAD **CEILING:** (1) LAYER 1/8"FRP FINISH BONDED TO 5/8" MOISTURE RESISTANT DRYWALL MATCHING FRP MOLDINGS @ PANEL SEAMS **ROOFING:** 12 GAUGE STEEL ROOF DECK SEAL WELDED ROOFING: EPDM RUBBER 1-PC. MEMBRANE, 60 mil, WHITE NOTE: REFLECTIVE COVER INSTALLED TO STEEL DECK WITH TWO PART TPA ADHESIVE MISC: 12 GA FORMED STEEL PERIMETER, ROOF TO SLOPE ONE WAY TO ONE SIDE (2) 3" PASSES ICYNENE PRO SEAL FOAM INSUL FOR R-38 MIN MISC: MISC: ROOF STRUCTURAL STEEL TO BE WIPED CLEAN AS REQUIRED AND PRIMED W/ KEM AQUA PRIMER F-DOORS: EXT. DOOR: 36"W x 96"H x 18-GA. COMM. INSUL. STEEL DOOR & FRAME, **VISION PANEL: NONE COLOR: SELECTED FROM MANUFACTURERS STD. COLORS** R.O. 37 3/4"W X 96 3/4"H THROAT: 5 3/8" HARDWARE: YALE 2100-SERIES PANIC w/ KEYED EXTERIOR LEVER; 7-PIN, FIGURE-8 CORE (4) STAINLESS-STEEL NON-REMOVABLE PIN HINGES. PER LEAF DOOR-O-MATIC CLOSER MFR'S STANDARD LOW-PROFILE THRESHOLD WEATHERSTRIPPING MAGNELINK MLT-E03-S DOOR ALARM SWITCH EXT. DOOR: 72"W x 96"H x 18-GA. COMM. INSUL. STEEL DOOR & FRAME, VISION PANEL: NONE COLOR: SELECTED FROM MANUFACTURERS STD. COLORS R.O. 73 3/4"W X 96 3/4"H THROAT: 5 3/8" HARDWARE: YALE 2100-SERIES PANIC w/ KEYED EXTERIOR LEVER; 7-PIN, FIGURE-8 CORE, ACTIVE LEAF ONLY (4) STAINLESS-STEEL NON-REMOVABLE PIN HINGES, PER LEAF DOOR-O-MATIC CLOSER, ACTIVE LEAF ONLY c: INTERIOR SURFACE BOLTS, INACTIVE LEAF ONLY REMOVABLE MULLION

MAGNELINK MLT-E03-S DOOR ALARM SWITCH, ACTIVE LEAF ONLY

MFR'S STANDARD LOW-PROFILE THRESHOLD

WEATHERSTRIPPING

G-WINDOWS: NONE

MISC:

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SKIRTING:

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12

NONE SUPPLIED

CANOPIES 24"W x 20"D.



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SHIP LOOSE POWDER COATED STEEL CANOPIES OVER EXTERIOR DOORS AND FAN LOUVERS

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<u>-LLE(</u>	TRICAL: PANELBOARD:	120/240 V., 1-PHASE, 60 HZ, 3-WIRE, 400 AMP,	J-PLUMBING	<u>3:</u>	NONE		
_	OEDV ENT	MAIN BREAKER TYPE 22k AIC, w/ (42) BOLT-IN BRANCH BREAKERS	K-H.V.A.C.:				
a	SERV ENT:	2" EMT THRU FLOOR : ALL SERVICE ENT. WIRING TO BE TYPE THWN COPPER.		ATING/	(1) BARD W42AC-A10BXXXXJ WALL MOUNT HVAC UNITS		
	NOT	PROVIDED & INSTALLED BY KETSTONE ON SITEINCLUDING ALL		OLING:	HIGH PRESSURE CONTROL		
	₽ E∩	IRED FEEDER WIRING, CONDUIT, ETC., TO CONNECT FACTORY			LOW PRESSURE CONTROL		
	DC PANEL:	EATON DC 225A PANELBOARD #P2J225BT60AH01, FD MAIN BREAKER (FD3225)			COMPRESSOR CONTROL MODULE		
	DOI/MALL.	(60) 20A 1P GHB BRANCH BREAKERS (GHB1020)			LOW AMBIENT CONTROL		
		INSTALLED IN THE PLANT			ALARM RELAY		
а	DC PANEL:	DC PANEL DISCONNECT SUPPLIED AND INSTALLED BY KEYSTONE ON SITE			SG-5 SUPPLY AIR WALL GRILLE		
-	 -				RG-5 RETURN AIR WALL GRILLE		
}	WIRING:	SURFACE-MOUNTED EMT (w/ #12 THHN 900 COPPER, MIN WIRE SIZE)	0 514	IALICT	BARD 8403-060 7 DAY PROGRAMMABLE THERMOSTAT	.NI	
а	WIRE WAY:	NEMA 1 HINGED COVER WÎRE WAY, 6"x 6", MOUNTED NEAR CEILING,	2 EXH	HAUST	(1) GRAINER 7F667 1095 CFM WALL MOUNT EXHAUST FA	MN	
					CONTROLLED BY HYDROGEN GAS SENSOR R.O. 16 3/4" x 16 3/4" @ 96" AFF to CENTER		
		AROUND BUILDING INTERIOR PERIMETER	3 EXI	HAUST	(1) GRAINER 4C557 MOTORIZED INTAKE LOUVER		
ļ.	GROUNDING:	INTERIOR GROUNDING HALO LOOP / #2 STRANDED COPPER (NOMINAL 88 LINEAL FEET)	J LAF	I/ \OO I	(1) GRAINER 4C557 MOTORIZED INTAKE LOOVER (1) GRAINER 24N064 MOTOR		
		HARGER #HSC100R56 STANDOFF MOUNTS; FASTEN TO STUDS, 48" APART MAX.			CONTROLLED BY HYDROGEN GAS SENSOR		
		HALO TO BE BOLTED TO STEEL FRAME WITH A COMPRESSION LUG			R.O. 16 3/4" x 16 3/4" @ 96" AFF to CENTER		
10	CDOLINIDING:	HADGED CDI SEDIES #SCCD 2 4/4"v 4"v 40" CDOLIND DAD/ ASSOCIATED CODDED WIDE		NOTE:	: OUTDOOR INTAKE AIR DAMPER TO BE IN CLOSED POSI	ΓΙΟΝ FOR SHIPPING.	
l a	GROUNDING:	HARGER GBI SERIES #SCGB-3 1/4"x 4"x 10" GROUND PAD, w/ ASSOCIATED COPPER WIRE			: INTAKE AIR DAMPER MUST BE ADJUSTED ON SITE FOR	- · · · · · · · · · · · · · · · · · · ·	
		& BURNDY FITTINGS QUANTITY (4)			PROPER AIRFLOW SEE HVAC UNIT OPERATING INSTR	UCTIONS.	
5	INT. LIGHTS:	WILLIAMS 17-4-232-A-EB2-UNV w/ ELECTRONIC BALLAST & (2)T-8 LAMPS					
•			L-FURNITUE	RE & INTERIOR FUR	NISHINGS:		
3	EGRESS LTG:	EXIT/EMERGENCY LIGHT W/ BATTERY PACK, COOPER APC7R					
	 	EMERGENCY LIGHT W/ BATTERY PACK - UP 108" TO BOTTOM	M-MISCELL	ANEOUS:	DVDQQUADD QLQLEQUIDMENT NQUIDMENT NO.		
		w/ EXTERIOR REMOTE HEAD (W.P.)	1		PYROGUARD 6'x8' EQUIPMENT MOUNTING BOARD PAIN	I FD MHI LE	
	NOT	: EXT. HEAD SHIPPED LOOSE, FOR INSTALLATION BY KEYSTONE ON SITE.	2 0'''	DI OOSE:	(2) SETS STEDS AND DI ATTORMS		
			∠ SHI	P LOOSE:	(2) SETS STEPS AND PLATFORMS THIRD PARTY LABEL AND INDIANA INSIGNIA		
7	RECEPTS:	HUBBELL #CR201 DUPLEX 125V/20A, NEMA 6-20R, UP 18" TO BOTTOM			THIRD PARTY LABEL AND INDIANA INSIGNIA O AND M MANUAL		
		UNLESS OTHERWISE NOTED, GROUNDING TYPE			ALL SYSTEMS TESTED AND DOCUMENTED PRIOR TO DE	-DARTHRE	
	DE055-1	ACTIVIDADA BUBLEVIANEATUED DECISERADA CONTRACTOR CONTRA			ALL STSTEINIS TESTED AIND DOGONIENTED FRIOR TO DE	I ANTONL	
3	RECEPTS:	125V/20A DUPLEX WEATHER-RESISTANT GFCI, NEMA 6-20R	UNIT LABEL	S.	THIRD PARTY LABEL STATE OF INDIANA		
	NOT	IN WEATHERPROOF-IN-USE ENCLOSURE, UP 6" ABOVE FLOOR	OTHE LADEL	· - ·	DATA PLATES AND LABELS LOCATED ON LOAD CENTER		
	NOT	: ALL RECEPTS ARE TO BE GROUNDING TYPE			COVER, UNLESS OTHERWISE SPECIFIED.		
.	SWITCHES:	LEVITON 3-WAY SWITCH w/ IDV/15 SENSOD LID 44" TO DOTTOM			MBI LABEL		
) 10	SWITCHES: SWITCHES:	LEVITON 3-WAY SWITCH w/ IPV15 SENSOR, UP 44" TO BOTTOM LEVITON 3-WAY SWITCH w/ IPVOR SENSOR,UP 44" TO BOTTOM	DECAL TYP	E:	NONE		
i U	GVVI I OI ILG.	LEVITOR 3-VVAT SVVITOTI W/ II VOIX SENSOIX, OF 44 TO BOTTOW					
11	DATA / PHONE DROE	S: 4x4 JUNCTION BOX w/ 1 GANG PLATER RING, UP 18"TO BOTTOM, UNLESS OTHER-			GENERAL SPECIFICATION NOTES:		
	,	WISE NOTED: 3/4" EMT THROUGH FLOOR					
			1.)	BUILDING NOT	TO BE LOCATED IN A DESIGNATED FIRE ZONE.	N IN /	
12	FIRE ALARM:	CEILING MOUNTED SMOKE DETECTOR: GRAINGER 1XTG6 KIDDE	2.)		G SHALL BE LOCATED MORE THAN 10 FEET AWAY FROM A		
		BATTERY OPERATED SMOKE DETECTOR (2), w/ GRAINGER		PROPERTY LIN	NE OR ANY INTERIOR LOT LINE BETWEEN IT AND ANY OTH	IEK BUILDING.	
		3KN55 RELAY MODULES, WIRED w/ HONEYWELL GENESIS	2)	THIS BITTLE DIVIS	G SHALL BE LOCATED MORE THAN 30 FEET AWAY FROM A	NIV	
		41061104 RISER CABLE	3.)		3 SHALL BE LOCATED MORE THAN 30 FEET AWAY FROM A NE OR ANY INTERIOR LOT LINE BETWEEN IT AND ANY OTH		
				FRUPER I Y LII	NE ON AINT INTERIOR LOT LINE BETWEEN IT AIND AINY OFF	ILK DUILDING.	
13	MISC:	ALARM JCT. BOX: HOFFMAN ASE12X12X4NK, 12"x 12"x 4", SCREW COVER,	4.)	THIS BI III DIVIC	G NOT TO BE LOCATED IN A FLOOD PRONE AREA.		
		NEMA 1, INSTALLED UP 48" AFF TO BOTTOM; WITH:	4.)	IT IIO DUILDING	S NOT TO BE LOCATED IN AT LOOD FROME AREA.		
		(2) GE CR151B20 12-POINT TERMINAL BLOCKS	5.)	WHITI FY MFG	S. CO., INC. IS NOT RESPONSIBLE FOR THE LOCAL		
		(1) GRAINGER 53MJ1 RELAY	J.,		DE REQUIREMENTS OVER AND ABOVE THE ENCLOSED		
1.4	MICC.	(1) GRAINGER 6X156 RELAY BASE			ONS. THE SPECIFICATIONS ARE BASED ON THE DESIGN		
14	MISC:	SITE LIGHTING CONTROL; SQUARE-D 8903LG60V02C			OF THE CODES LISTED ABOVE.		
15	MICC	MOUNTED UP 44" TO BOTTOM					
15	MISC:	AUTOMATIC TRANSFER SWITCH, ASCO J3ATSA400FGX C 11 BE 24"w X 56"h X 14"d MOUNTED UP 36" TO BOTTOM	6.)	DUPLICATES (OF THIS BUILDING CAN BE BUILT AS A MIRROR IMAGE		
16	MISC:	ARRGH HYDROGEN GAS DECTECTOR HDG-DR, w/ FORM C CONTACTS	,		- -		
ı U	IVIIOO.	MOUNTED UP 36" TO BOTTOM WIRED TO ENERGIZE EXHAUST FAN AND	7.)	DUPLICATES (OF THIS BUILDING CAN BE BUILT AS A SHELL		
		MOUNTED UP 36 TO BOTTOM WIRED TO ENERGIZE EXHAUST FAIN AIND MOTORIZED INTAKE LOUVER.	•				
		MOTOMIZED HATAINE ECOVERY.	8.)	THIS BUILDING	G DOES NOT HAVE FIRE-RATED EXTERIOR WALLS.		
17	EXT. LIGHTS:	RAB WP1SN70/PC, 70-WATT HIGH-PRESSURE SODIUM, W/P, W/PHOTO CELL,	•				
•	_,	UP 82" TO TOP	9.)		G SHALL NOT BE LOCATED IN AREAS WITH SNOW, WIND, A		
8	MISC:	CHATSWORTH CEILING MOUNT CABLE TRAY (B-LINE), LENGTHS & FITTINGS		SEISMIC LOAD	OS IN EXCESS OF THOSE NOTED ABOVE IN BUILDING DESI	GN LOADS	
		PER SPECIFICATION GALVANIZED ATTACHED TO CEILING AND UNDER TRAY 8' O.C.					
		UNIISTRUT SEISMIC BRACING PER PARTS LIST					
		THIS DRAWING AND ALL dba Modular Built	ers Road Drawn By:			Serial No.	
	Descri	tion Date INFORMATION CONTAINED 2756 Fort Wayne P.O. BOX 505	Road Diawii by.		SPECIFICATIONS CONT.	40044	AUG, 20
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		MFG. CO., INC. WHITLEY MFG.	PG			7502 A	Page
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BUILDING INFORMATION:

BUILDING USE GROUP -----II-B (STEEL FRAME - UNPROTECTED) TYPE OF CONSTRUCTION -----SQUARE FOOTAGE -----420 SQ FT OCCUPANT LOAD OF BUILDING -----, OR LESS

BUILDING DESIGN LOADS:

FLOOR LIVE LOAD UNIFORM FLOOR LIVE LOAD CONCENTRATED FLOOR IMPACT LOAD FLOOR DEAD LOAD ROOF LIVE LOAD GROUND SNOW LOAD ROOF DEAD LOAD FLAT ROOF SNOW LOAD SNOW EXPOSURE FACTOR SNOW LOAD IMPORTANCE FACTOR THERMAL FACTOR	250 2000 N/A 20 30 25 15 20 1.00 1.1	PSF LBS LBS PSF PSF PSF PSF
RAIN ON SNOW SURCHARGE LOAD BASIC WIND SPEED	N/A 120	MPH
RISK CATEGORY	 	IVIFI
WIND EXPOSURE	C	
DESIGN WIND PRESSURE	TBD	PSF
SEISMIC IMPORTANCE FACTOR	1.25	
SPECTRAL RESPONSE COEFFICIENT SDS	0.07	
SPECTRAL RESPONSE COEFFICIENT SD1	0.075	
SITE CLASS	D	
BASIC SEISMIC-FORCE-RESISTING SYSTEM	A.14	
DESIGN BASE SHEAR	TBD	LBS
SEISMIC DESIGN CATEGORY	D	

2014	INDIANA BUILDING CODE (2012 IBC w/IN AMENDMENTS)
2014	INDIANA MECHANICAL CODE (2012 IBC w/IN AMENDMENTS)
2010	INDIANA ENERGY CONSERVATION CODE (90.1 2007 ASHRAE)
2012	INDIANA PLUMBING CODE (2006 IPC w/IN AMANDMENTS)
2009	INDIANA ELECTRICAL CODE (2008 NEC) CONFORMANCE TO THE ADAAG
2014	INDIANA FIRE CODE (2012 IFC w/IN AMENDMENTS)
2015	INDIANA FUEL AND GAS CODE (2012 IEGC w/IN AMENDMENTS)

BUILDING CODES:

- 1. ATTIC VENTILATION SHALL COMPLY WITH APPLICABLE CODES.
- 2. ALL LOCKS TO BE UNLOCKABLE FROM INTERIOR WITHOUT THE USE OF A KEY.
- 3. CORROSION RESISTANT FLASHING REQUIRED AT TOP AND SIDES OF DOORS, WINDOW, AND ROOF PENETRATORS.
- 4. SAFETY GLAZING SHALL BE INSTALLED PER APPLICABLE CODES.
- 5. EXTERIOR EGRESS ELEMENTS TO BE SITE PROTECTED FROM SNOW AND ICE ACCUMULATION.
- 6. DEALER SHALL BE RESPONSIBLE FOR ON SITE BARRIER FREE PROVISIONS INCLUDING ALL: ADA REQUIRED STEPS, RAMPS, HANDRAILS, PARKING, ETC. AND APPLICABLE SIGNAGE (INTERIOR AND EXTERIOR) FOR THE VISUALLY IMPAIRED AND NON-AMBULATORY

BUILDING CODE FIELD NOTES:

- 1. TIE-DOWN ANCHORING TO BE INSTALLED ON SITE
- 2. ELECTRICAL CONNECTIONS TO BE PROVIDED AND INSTALLED ON SITE
- 3. ALL ADA REQUIRED STEPS, RAMPS, HANDRAILS, PARKING, ETC... AND APPLICABLE SIGNAGE. (INTERIOR AND EXTERIOR) FOR THE VISUALLY IMPARED AND NON-AMBULATORY TO BE PROVIDED AND INSTALLED ON SITE

ELECTRICAL:

- 1. ALL RECEPTACLES TO BE GROUNDING TYPE.
- 2. ALL WIRING TO BE PER N.E.C.
- 3. MAIN PANEL TO BE MARKED "SUITABLE FOR USE AS SERVICE EQUIPMENT", AND HAVE BREAKER/FUSE TYPE OVERCURRENT PROTECTION.
- 4. PROPER THERMAL OVERLOAD PROTECTION TO BE PROVIDED FOR ALL MOTORS.
- 5. DISCONNECTING MEANS WITHIN SIGHT REQUIRED FOR ALL MOTORS.
- 6. WEATHERPROOF PROTECTION REQUIRED FOR ALL OUTDOOR LIGHTS AND / OR RECEPTACLES.
- 7. PROPER WORKING CLEARANCES TO BE PROVIDED AND MAINTAINED ABOUT ALL ELECTRICAL EQUIPMENT.
- 8. ALL FLUORESCENT FIXTURES REQUIRE THERMAL PROTECTION.
- 10. ALL EMERGENCY LIGHTING (IF REQUIRED) AND EXIT SIGNS WILL BE CONNECTED
- AHEAD OF ANY LOCAL SWITCHES PER NEC SECTION 700-12 (f).
- 11. ALL EMERGENCY LIGHTING HAS A BATTERY PACK TO ASSURE CONTINUED ILLUMINATION.
- 12. GROUNDING ELECTRODE SHALL BE INSTALLED IN ACCORDANCE WITH ARTICLE 250 N.E.C.
- 13. MAIN DISTRIBUTION PANEL (S) SHALL BE INSTALLED ON SITE
- 14. SERVICE ENTRANCE CONDUCTORS TO BE 75 COPPER TYPE THWN.

ELECTRICAL FIELD NOTES:

- 1. ELECTRICAL SERVICE ENTRANCE CONDUCTORS TO BE PROVIDED AND INSTALLED ON SITE
- 2. GROUNDING ELECTRODES TO BE PROVIDED AND INSTALLED ON SITE

MECHANICAL:

- 1. VENTILATION AIR, EXHAUST FANS AND VENTING EQUIPMENT PROVIDED IN ACCORDANCE WITH APPLICABLE CODES.
- 2. EXHAUST FANS TO BE INSTALLED PER APPLICABLE CODES.
- 3. RETURN AIR VIA RETURN AIR DUCT OR THRU GRILLE AT UNIT.
- 4. MECHANICAL VENTILATION PER APPLICABLE CODES.

STRUCTURAL:

- 1. TRUSSES IF INSTALLED, TO BE DESIGNED FOR LOAD AND APPLICATION USED.
- 7. EXTERIOR BRACING MAY BE PROVIDED WITH WOOD SIDING, 7/16 HARDBOARD SIDING, "STORM BRACE" EXTERIOR SHEATHING 3/8" CDX PLYWOOD W/ EXTERIOR GLUES, OR ANY APPROVED STRUCTURAL GRADE SHEATHING.

FIELD NOTE:

1. ALL LINES REPRESENTED BY A BROKEN LINE ON SCHEMATIC DRAWINGS SHALL BE PROVIDED AND INSTALLED ON SITE PER DEALER CONTRACTURAL AGREEMENT.

FOUNDATION:

- 1. LOADS ARE IN 1000LBS.
- 2. CRAWL SPACE VENTILATION SHALL NOT BE LESS THAN 1/150TH OF THE CRAWL SPACE HORIZONTAL AREA.
- 3. THE FOUNDATION PLAN PROVIDED WITH THIS BUILDING IS A SUGGESTED PLAN ONLY. FOUNDATIONS TO BE DESIGNED BY A PROFESSIONAL ENGINEER PER LOCAL SOIL AND CLIMATE CONDITIONS.
- 4. PROVIDE ACCESS TO CRAWL SPACE, MINIMUM 22" X 24"
- 5. MINIMUM FOOTING DEPTH 3'-6" OR AS REQUIRED BY LOCAL CONDITIONS.

FIELD NOTE:

1. ALL FOUNDATION WORK PROVIDED ON THE FOUNDATION DRAWING IS TO BE PROVIDED AND INSTALLED ON SITE PER DEALER UNDER CONTRACTUAL AGREEMENT.

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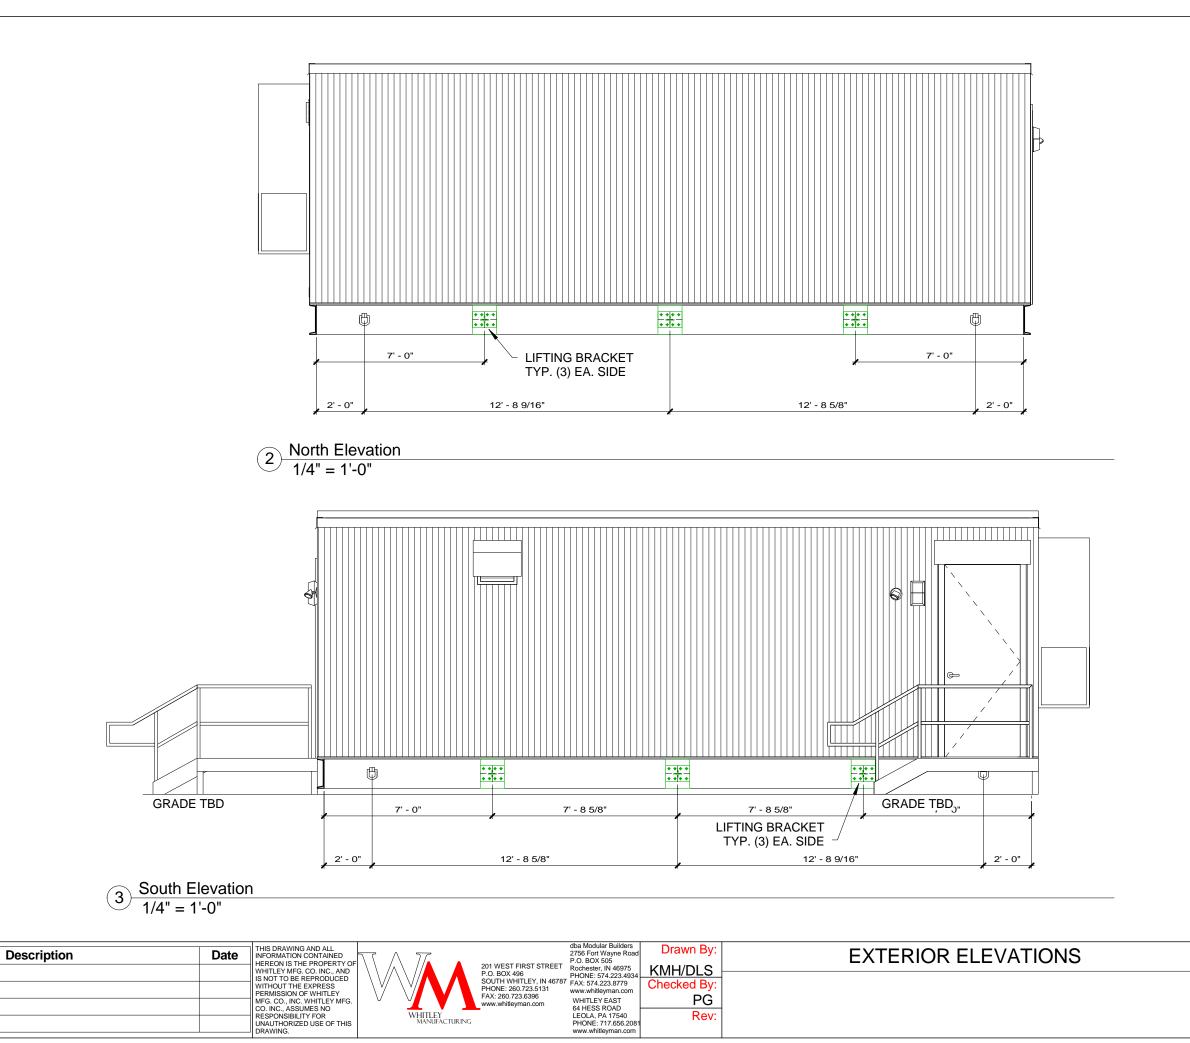


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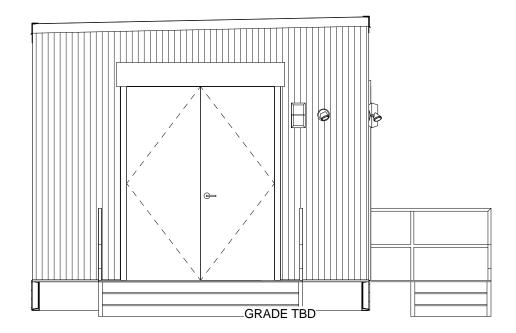
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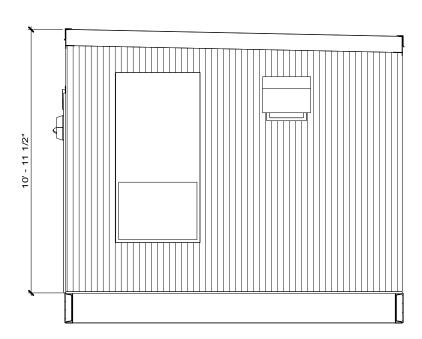
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2 West Elevation 1/4" = 1'-0"



1 East Elevation 1/4" = 1'-0"

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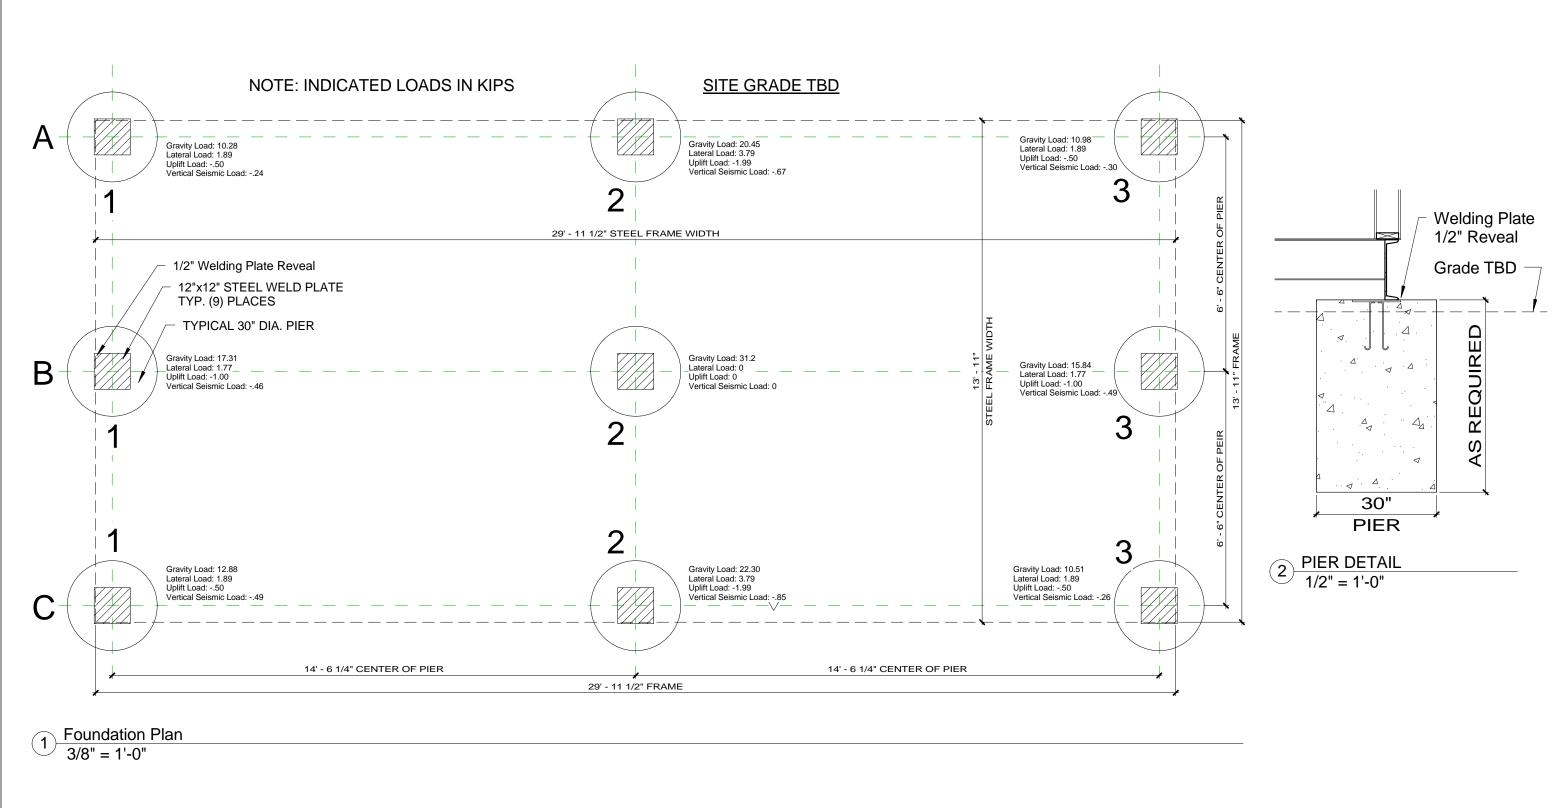
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Quote No. ## 1/4" = 1'-0"
Nodel No. 7582A

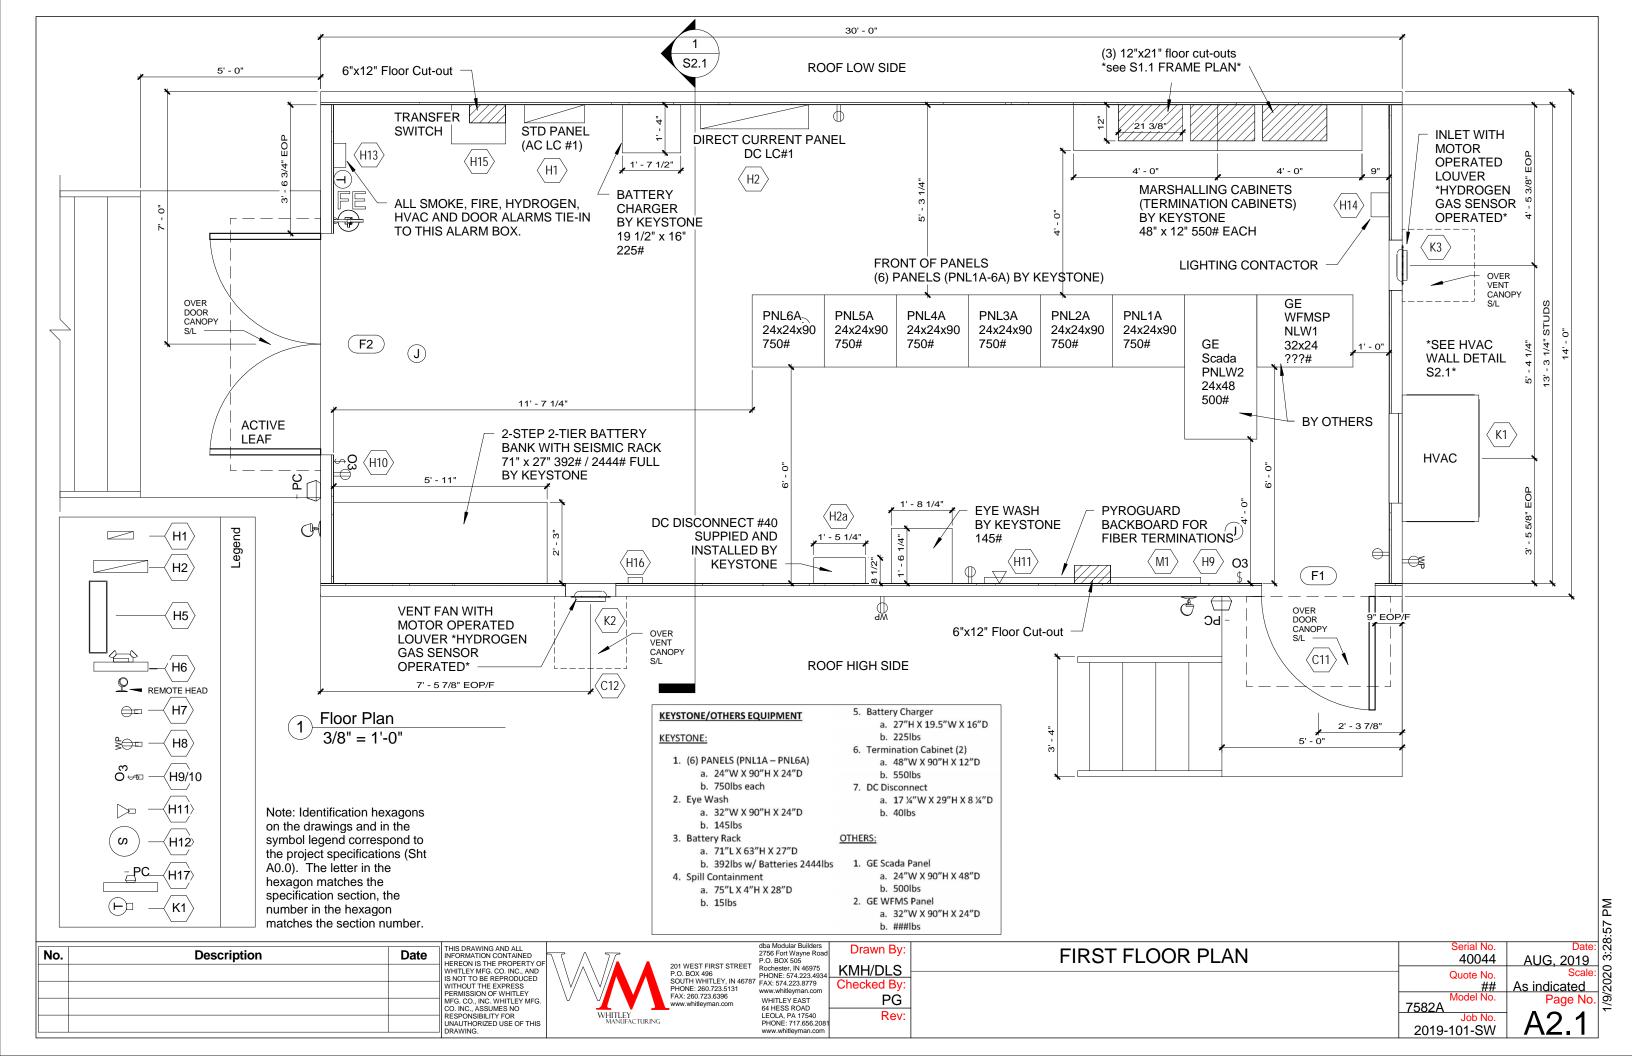
Job No. 2019-101-SW

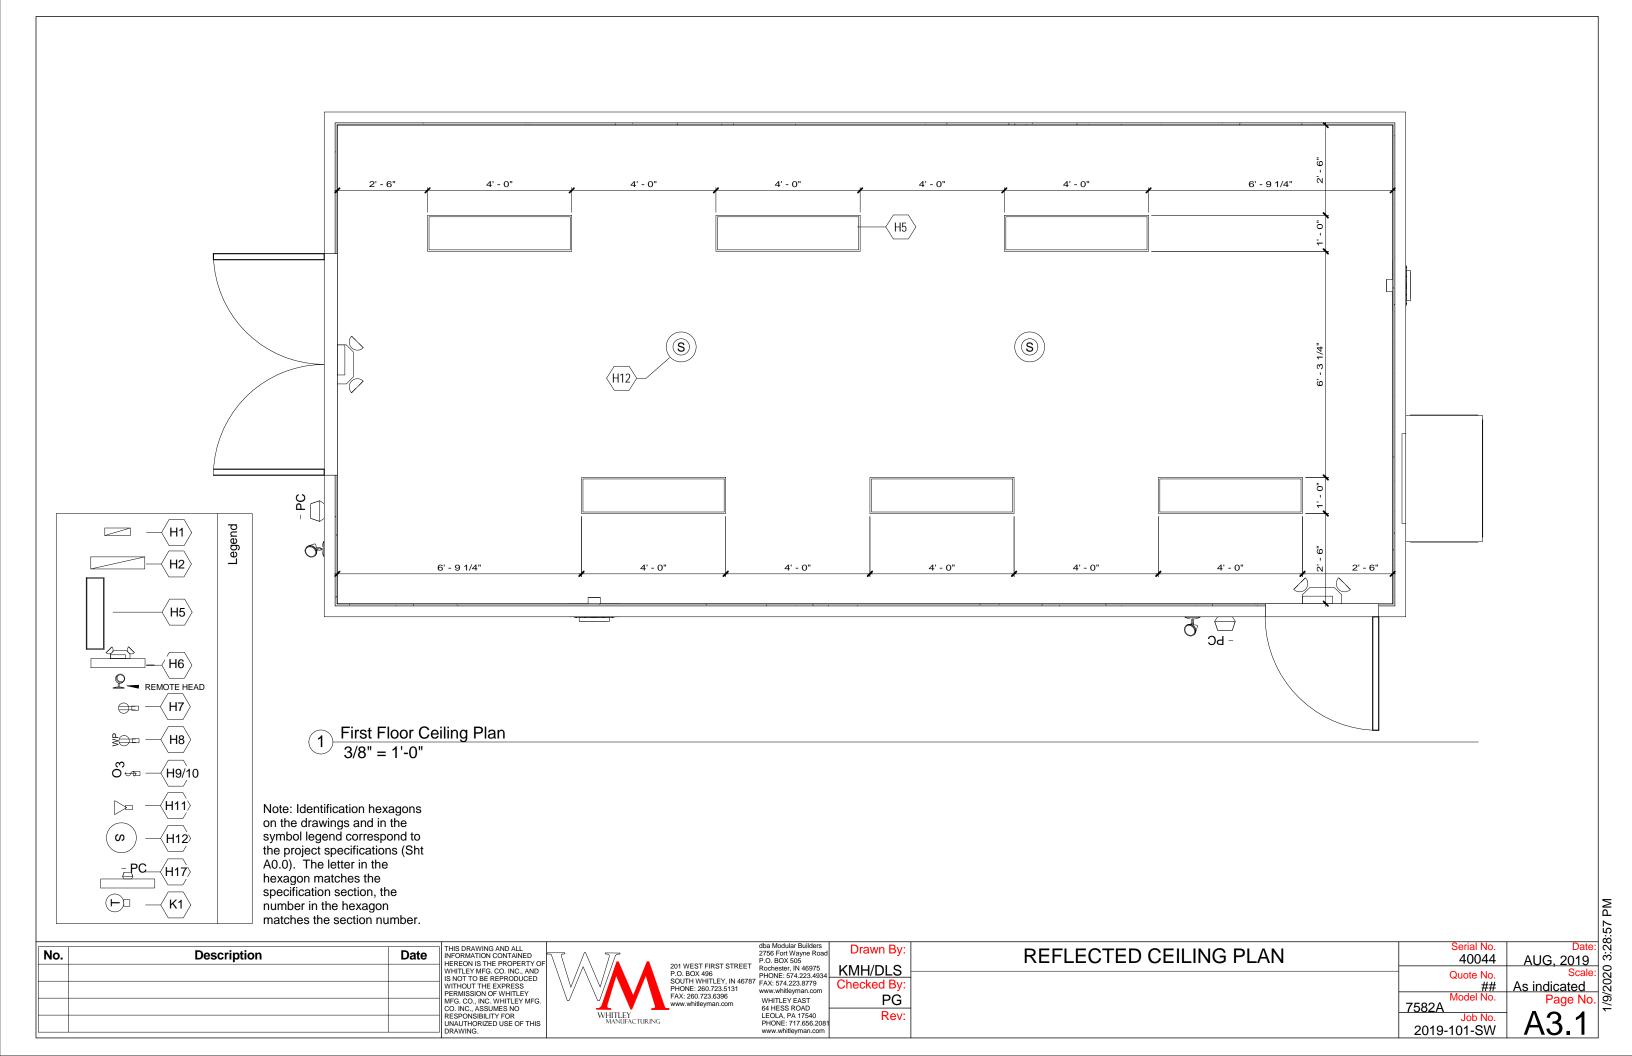
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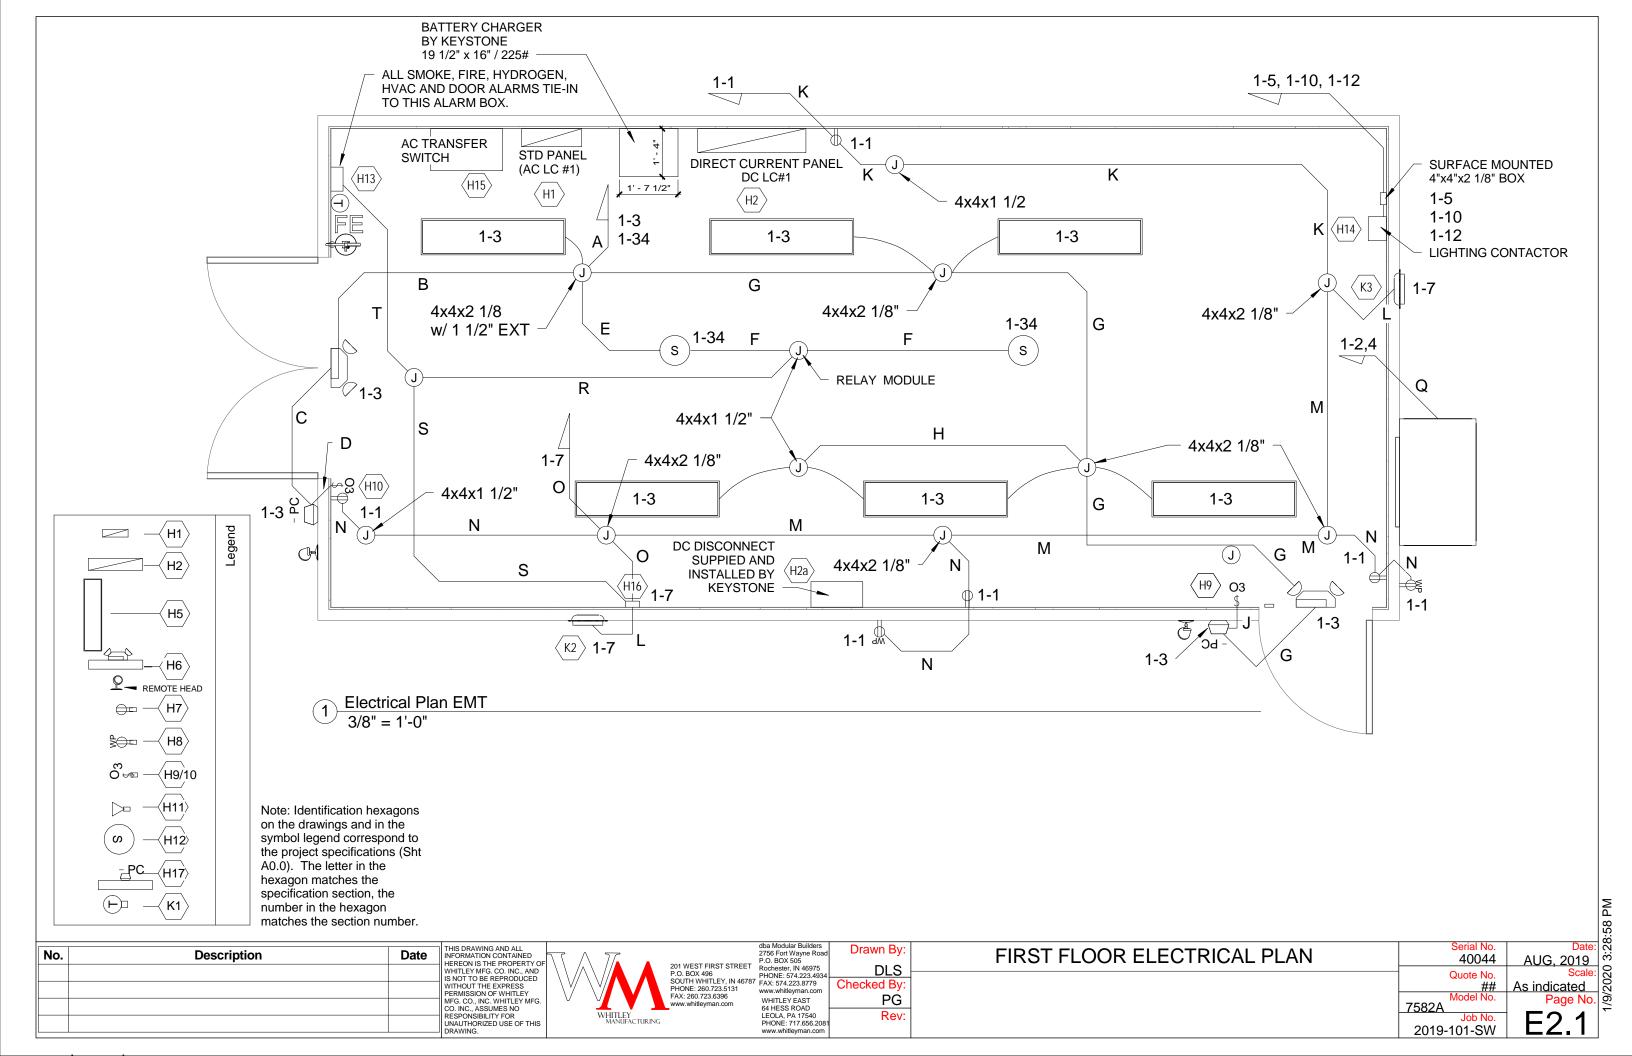


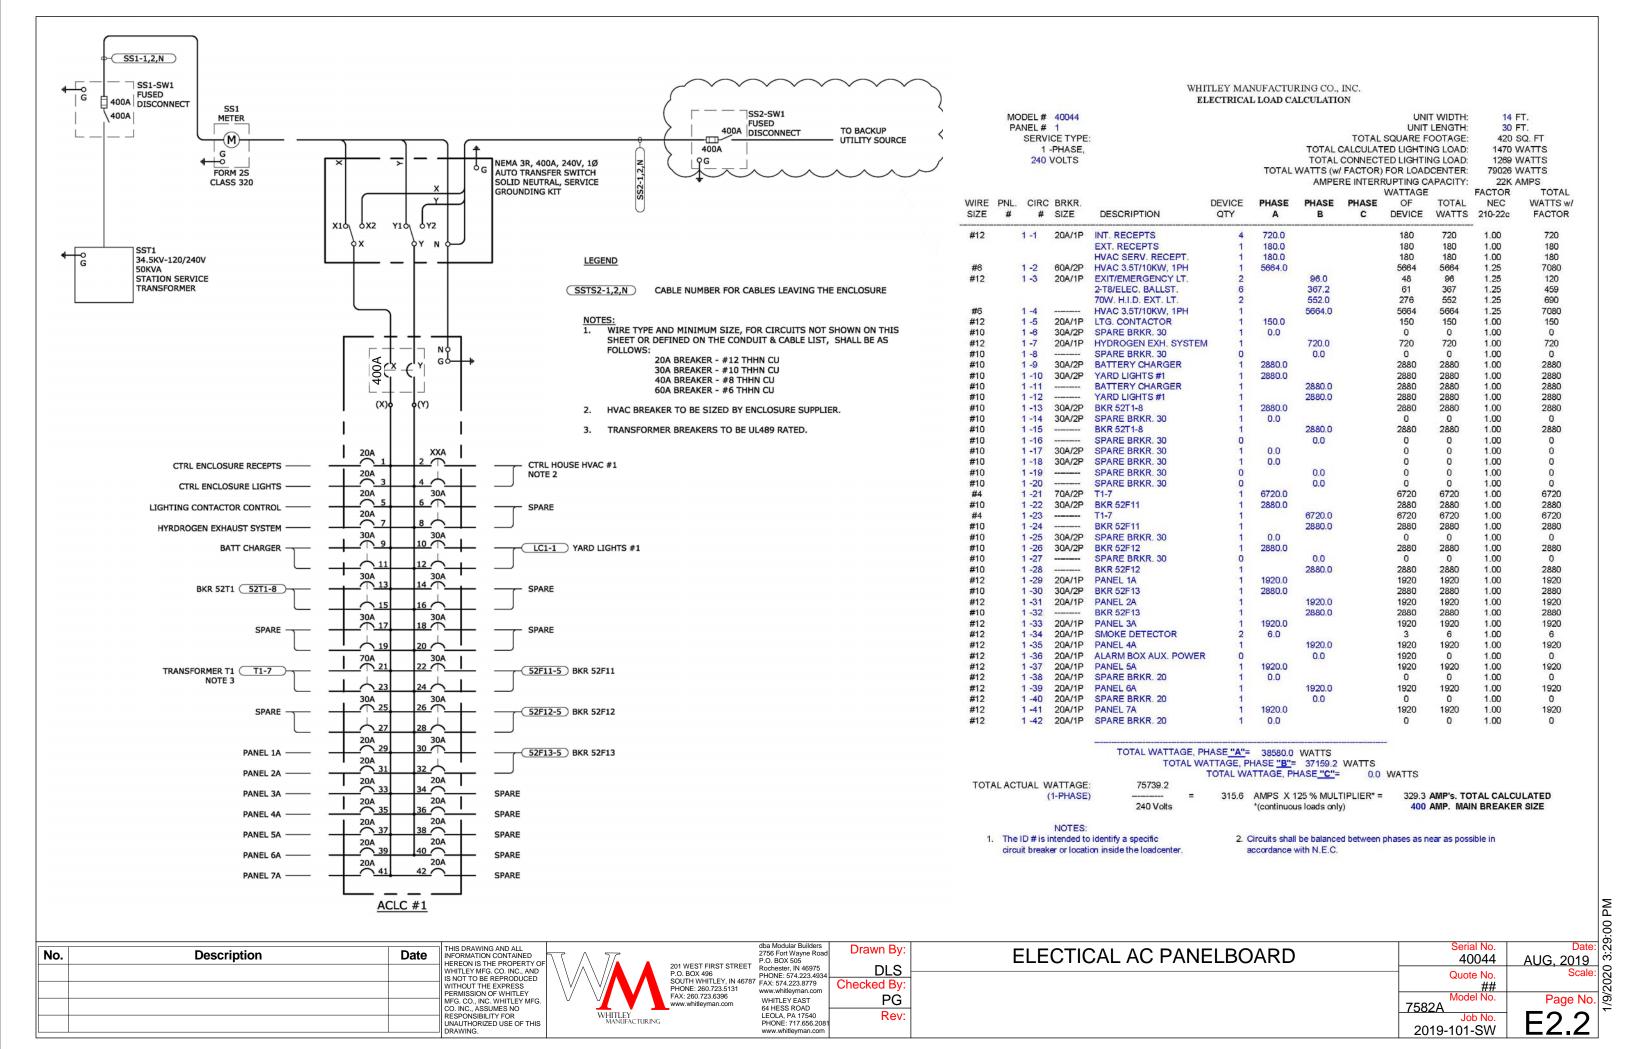
No.	Description	Date	THIS DRAWING AND ALL INFORMATION CONTAINED HEREON IS THE PROPERTY OF	^ 7 <u>^</u>	201 WEST FIRST STREE	dba Modular Builders 2756 Fort Wayne Road P.O. BOX 505 Rochester, IN 46975	Drawn By:	FOUNDATION	Serial No. 40044	AUG, 2019
			WHILEY MFG. CO. INC., AND IS NOT TO BE REPRODUCED WITHOUT THE EXPRESS PERMISSION OF WHITLEY MFG. CO., INC. WHITLEY MFG.		P.O. BOX 496 SOUTH WHITLEY, IN 467 PHONE: 260.723.5131 FAX: 260.723.6396 www.whitleyman.com	PHONE: 574.223.4934 FAX: 574.223.8779 www.whitleyman.com WHITLEY EAST 64 HESS ROAD	Checked By:		Quote No. ## Model No.	As indicated Page No.
			CO. INC., ASSUMES NO RESPONSIBILITY FOR UNAUTHORIZED USE OF THIS DRAWING.	WHITLEY MANUFACTURIN		64 HESS ROAD LEOLA, PA 17540 PHONE: 717.656.2081 www.whitleyman.com	Rev:		7582A Job No. 2019-101-SW	A2.0

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DEVICE

MODEL# 7582a PANEL# 2 SERVICE TYPE:

DIRECT CURRENT PANEL 125 VOLTS

WIRE PNL. CIRC BRKR.

		C BIXIX.		DEVICE			DEVICE	IOIAL
SIZE	#	# SIZE	DESCRIPTION	QTY	Α	В	WATTAGE	WATTS
#10	2 -1	30A/2P	LINE RELAYING	1	1950.0		1950	1950
#10	2 -2	30A/2P	34.5kV BUS 1	1	2400.0		2400	2400
#10			LINE RELAYING	1		0.0	0	0
#10			34.5kV BUS 1	1		0.0	0	0
#10	2 -3	30A/2P	LINE RELAYING	1	1950.0		1950	1950
#10	2 -4	30A/2P	CKT # 1 BKR 52T1	1	1950.0		1950	1950
#10			LINE RELAYING	1		0.0	0	0
#10			CKT # 1 BKR 52T1	1		0.0	0	0
#10	2 -5	30A/2P	TRANSFRMR T1	1	2400.0		2400	2400
#10	2 -6	30A/2P	CKT # 2 BKR 52T1	1	2400.0		2400	2400
#10			TRANSFRMR T1	1		0.0	0	0
#10			CKT # 2 BKR 52T1	1		0.0	0	0
#10	2 -7	30A/2P	BKR 52F11	1	1950.0		1950	1950
#10	2 -8	30A/2P	BKR 52F12	1	1800.0		1800	1800
#10			BKR 52F11	1		0.0	0	0
#10			BKR 52F12	1		0.0	0	0
#10	2 -9	30A/2P	BKR 52F13	1	1950.0		1950	1950
#10	2 -10		SPARE, 30A	1	0.0		0	0
#10			BKR 52F13	1		0.0	0	0
#10			SPARE, 30A	1		0.0	0	О
#12	2 -1	1 20A/2P	SPARE, 20A	1	0.0	1 EXAL	0	O
#10	2 -1:		SPARE, 30A	1	0.0		0	O
#12			SPARE, 20A	1		0.0	0	0
#10			SPARE, 30A	1		0.0	0	Ō
#12	2 -1	3 20A/2P	SPARE, 20A	1	0.0		Ö	Ö
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#10	2 -10		SPARE, 30A	1	0.0		Õ	Ö
#12	2 1		SPARE, 20A	1	0.0	0.0	Ö	Õ
#10			SPARE, 30A	i i		0.0	Ö	Ö
#12	2 -1		SPARE, 20A	4	0.0	0.0	Ö	Ö
#10	2 -18		SCADA SCADA	4	1800.0		1800	1800
#12	2 1		SPARE, 20A	4	1000.0	0.0	0	0
#10			SCADA SCADA	4		0.0	0	0
#10	2 -19	30A/2P	RTAC & GPS	1	1950.0	0.0	1950	1950
#6	2 -20		BATTERY CHARGER	1	2500.0		2500	2500
± #10	2 -21	, 50AZ	RTAC & GPS	1	2000.0	0.0	0	0
#10			BATTERY CHARGER	1		0.0	0	0

TOTAL WATTAGE, PHASE "B"= 0.0

TOTAL ACTUAL WATTAGE: (1-PHASE) 25000.0 125 Volts

200.0 AMP's. TOTAL CALCULATED 200 AMP. MAIN BREAKER SIZE

NOTES:

1. The ID # is intended to identify a specific circuit breaker or location inside the loadcente 2. Circuits shall be balanced between phases as near as possible i accordance with N.E.C.

WATTS

DEVICE TOTAL

No.	Description	Date

DCLC #1

(+)

#4/0 THHN CU. RED

> 125V BATTERY

> > (-)

200 A DISCONNECT SWITCH - #4/0 THHN CU. BLACK

LINE RELAYING

LINE RELAYING

TRANSFORMER T1

BKR 52F11

BKR 52F13

SPARE

SPARE

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WHITLEY MANUFACTURING

34.5KV BUS1

CKT #1

CKT #2

BKR 52T1

BKR 52F12

SPARE

SPARE

SPARE

SPARE

SCADA

BATTERY CHARGER

STATION BATTERY CHARGER, 20A

BKR 52T1

dba Modular Builder. 2756 Fort Wayne Ro. 2756 Fort Wayne Ro. 201 WEST FIRST STREET Rochester, IN 46975 P.O. BOX 496 ROCHEST FAX: 574.223.4934 FAX: 260.723.6396 www.whitleyman.com WHITLEY EAST 64 HESS ROAD LEOLA, PA 1754

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#6 THHN CU BLACK

#6 THHN CU RED

#6 THHN CU. BLACK

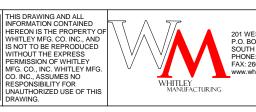
ACLC1 #6 THHN CU.

ELECTRICAL DC PANELBOARD	Serial No. 40044	Date: స్ట్రి AUG, 2019
	Quote No. ##	Scale: 070
	Model No. 7582A	Page No.
	Job No. 2019-101-SW	E2.3

		1				PAGE # 1
SERIAL #:	40044	· · · · · · · · · · · · · · · · · · ·		JOB:	BITTER RIDGE	SUBSTATION
DWG. #				JOB#	2019-101-SW	
MOD.#	7582A		.,,,,,,,,,,,,,,,,,,,,,,,,,,,,,,,,,,,,,,			
CONDUIT	CIRC.	CONDUIT	WIRE SIZE	WIRE	COLORS	USE
RUN ID.	NUMBER	TYPE/SIZE	#12, UN-	B: BLACK	R: RED	L: LINE N: NEUTRAL
NO./LETTER		(1/2" EMT, UN-	LESS NOTED	BL: BLUE	BR: BROWN	G: GROUND S/L: SWITCH LEG
		LESS NOTED)		Y: YELLOW	O: ORANGE	CN: COMMON NEUTRAL
					GR: GRAY	T: TRAVELER IG: ISOL. GROUND
				G: GREEN	P: PURPLE	GFP: GND FAULT PROTECTED
				PK: PINK		
Α	1-3 1-3				R W	L N
	1-34				В	L
	1-34				w	N
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В	1-3				R	L
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F	1-34				В	
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	1-3				G	G
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	1-3				0	S/L
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SERIAL #:	40044			JOB:	BITTER RIDGE S	UBSTATION		
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MOD.#	7582A		H	000#	2013-1	01-000		
			H			H		
CONDUIT	CIRC.	CONDUIT	WIRE SIZE		RE COLORS		USE	
RUN ID. NO./LETTER	NUMBER	TYPE/SIZE (1/2" EMT, UN-	#12, UN- LESS NOTED	B: BLACK	R: RED BR: BROWN	L: LINE G: GROUND S	N: NEUTRAL /L: SWITCH LEG	
NO./LETTER		LESS NOTED)	LESS NOTED	Y: YELLOW	O: ORANGE		CN: COMMON NEUTRAL	
		ELGO NO (LE)		W: WHITE	GR: GRAY	T: TRAVELER IG		
				G: GREEN			GFP: GND FAULT PROTECTED	
				PK: PINK				
L	1-7				0	S/L		
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	1-7				R	L		
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S	1-7	-			R P	1% RELAY 2% RELAY		
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	1-7				G	G		
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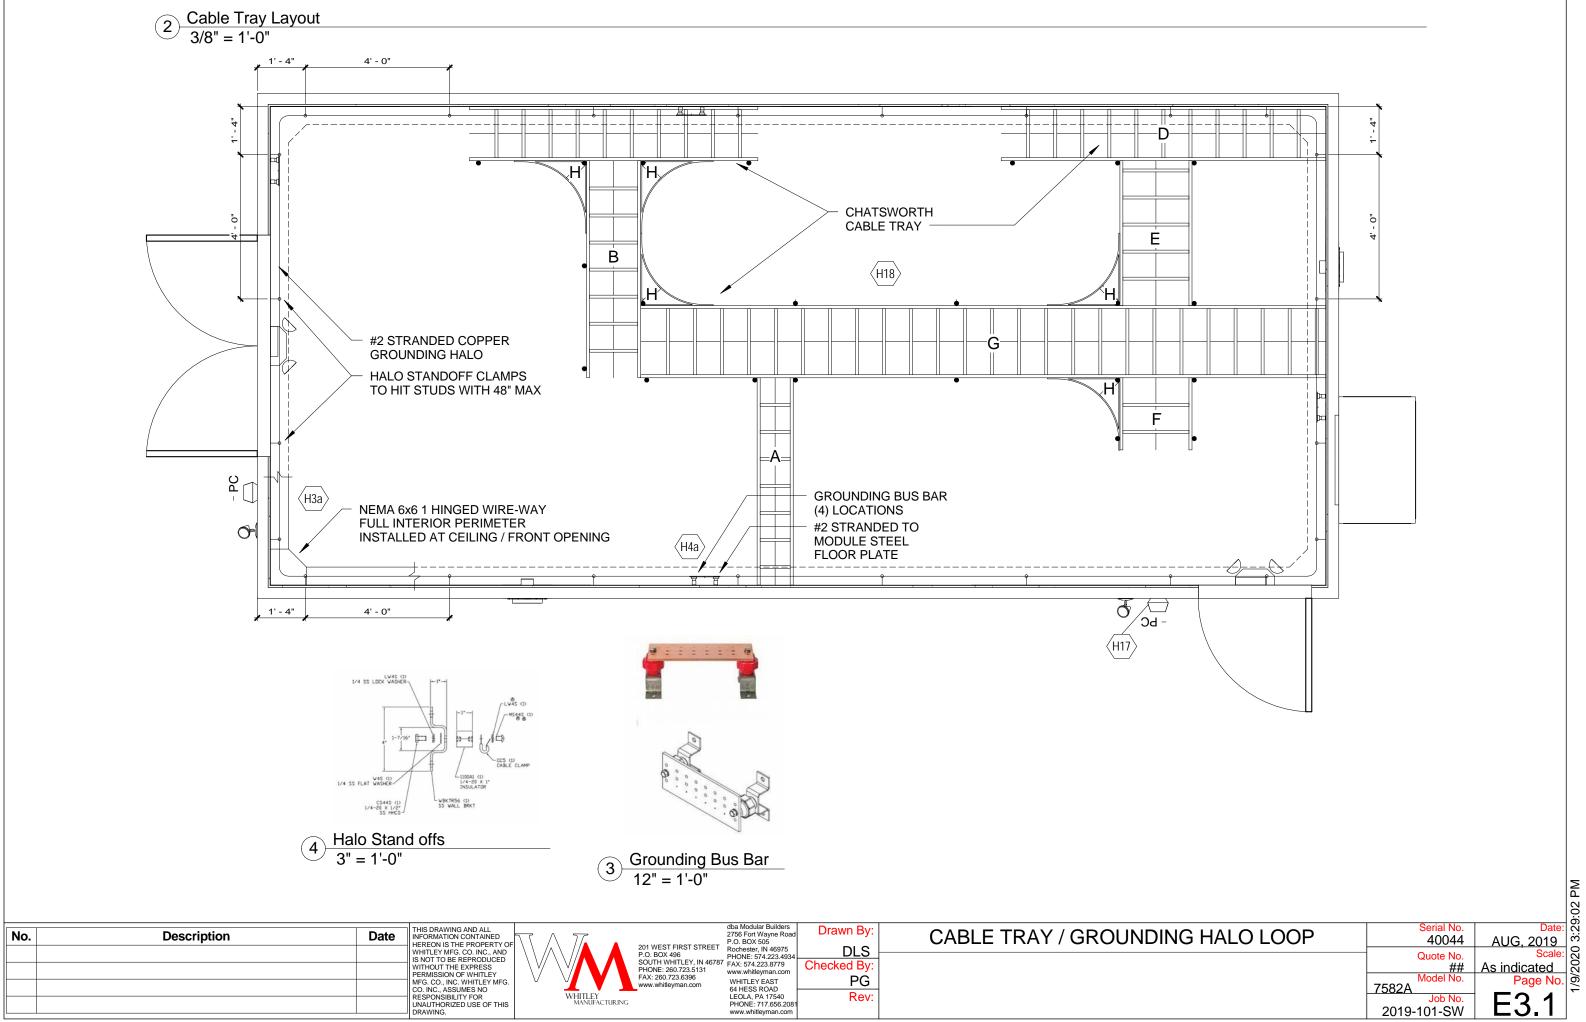
No.	Description	Date



dba Modular Builders
2756 Fort Wayne Road
P.O. BOX 496
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SOUTH WHITLEY, IN 46787
FAX: 574.223.8779
PHONE: 260.723.6396
www.whitleyman.com
WHITLEY EAST
64 HESS ROAD
LEOLA, PA 17540
PHONE: 717.656.2081
www.whitleyman.com

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CONDUIT WIRE FILLS	Serial No. 40044 Quote No. ##	Date: AUG, 2019 Scale:
	Model No. 7582A Job No. 2019-101-SW	Page No. E2.4



2019-101-SW

	CHATSWORTH UL Classified Cable Runway Accessories Schedule					
Count	Equipment Equipment Part Count Number Abbreviation Manufacturer Number Part Description					
5	Н	СТА	Chatsworth Products, Inc.	11959-724	Ladder Cable Pathway Corner Bracket, 24 Inch Wide, Black	

			011/(100001	CITTOL Olasc	sinca Gabic IV	tunway Sched	uic	
	Equipment	Equipment Abbreviatio					Part	
Count	Number	n	Manufacturer	Height	Width	Length	Number	Part Description
1	A	СТ	Chatsworth	1 1/2"	12"	5' - 9"	11275-012	UL Classified Cable Runway,
1	В	СТ	Products, Inc. Chatsworth Products, Inc.	1 1/2"	18"	6' - 0 1/4"	11275-018	12" Wide, Gold UL Classified Cable Runway, 18" Wide, Gold
1	С	СТ	Chatsworth Products, Inc.	1 1/2"	18"	8' - 0"	11275-018	UL Classified Cable Runway, 18" Wide, Gold
1	D	СТ	Chatsworth Products, Inc.	1 1/2"	18"	9' - 0"	11275-018	UL Classified Cable Runway, 18" Wide, Gold
	E	СТ	Chatsworth Products, Inc.	1 1/2"	24"	4' - 0 1/4"	11275-024	UL Classified Cable Runway, 24" Wide, Gold
	F	СТ	Chatsworth Products, Inc.	1 1/2"	24"	2' - 0"	11275-024	UL Classified Cable Runway, 24" Wide, Gold
	G	СТ	Chatsworth Products, Inc.	1 1/2"	24"	19' - 0"	11275-024	UL Classified Cable Runway, 24" Wide, Gold

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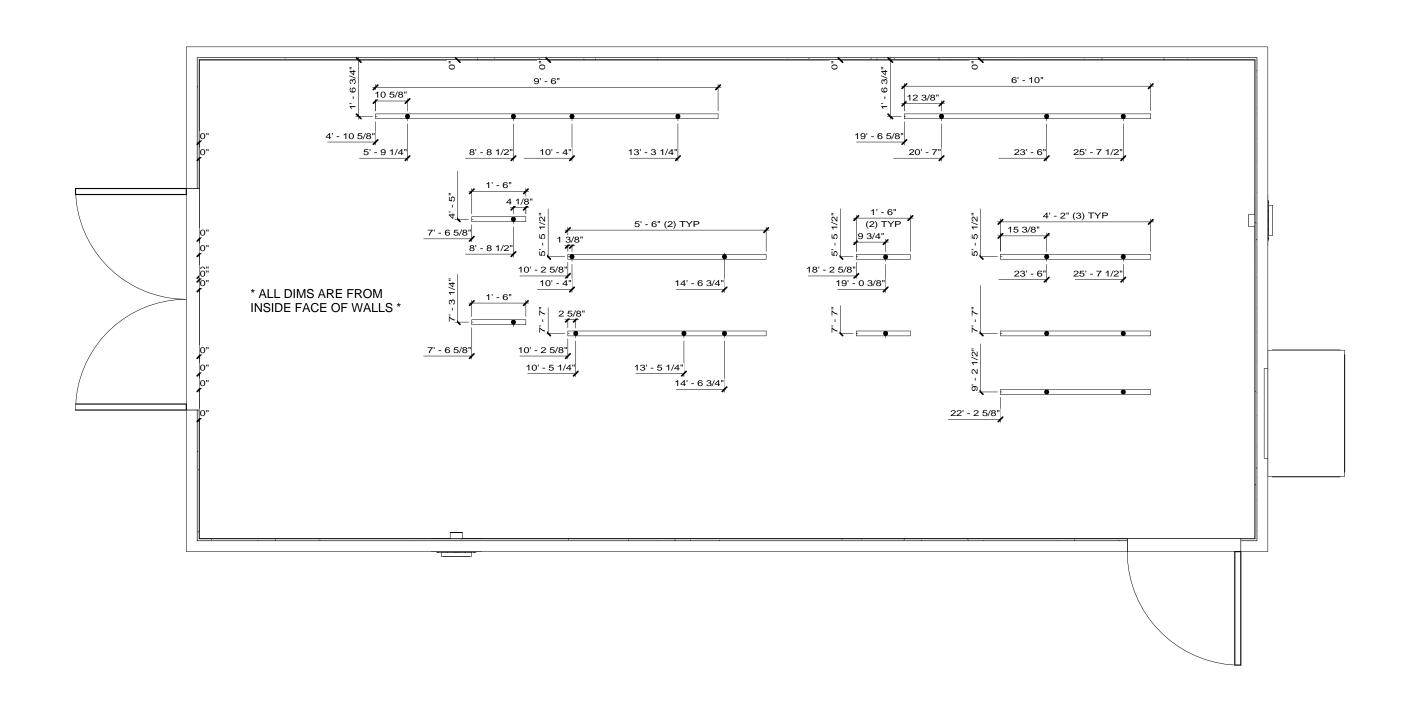


	dba Modular Builders	Г
	2756 Fort Wayne Road	l
	P.O. BOX 505	l
ΕT	Rochester, IN 46975	l
	PHONE: 574.223.4934	L
3787	FAX: 574.223.8779	l
	www.whitleyman.com	l
	WHITLEY EAST	l
	64 HESS ROAD	H
	LEOLA, PA 17540	l
	DHONE: 717 656 2001	ı

lders e Road	Drawn By:
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CABLE TRAY PARTS LIST

Serial No.	Date:
40044	AUG, 2019
Quote No.	Scale:
##	
Model No.	Page No.
Job No.	
2019-101-SW	□ 3.∠



Cable Tray Uni-strut Mounting
3/8" = 1'-0"

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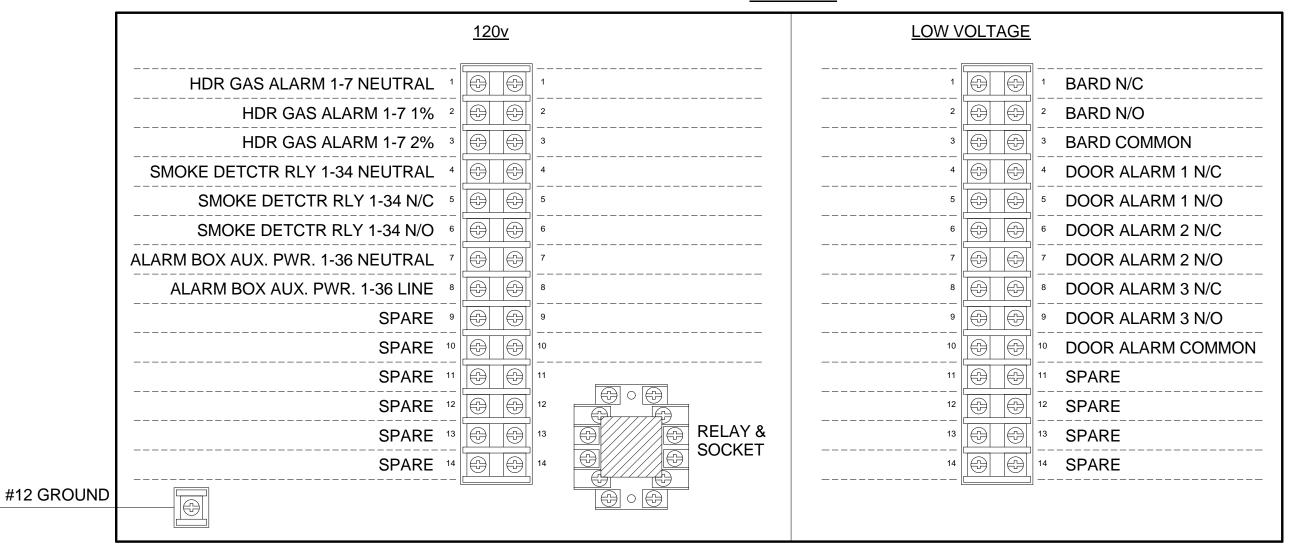
	201 WEST FIRST STREET P.O. BOX 496 SOUTH WHITLEY, IN 46787 PHONE: 260.723.5131 FAX: 260.723.6396 www.whitleyman.com
WHILEI	

	dba Modular Builder
	2756 Fort Wayne Ro
	P.O. BOX 505
REET	Rochester, IN 46975
	PHONE: 574.223.49
46787	FAX: 574.223.8779
	www.whitleyman.com
	WHITLEY EAST
	64 HESS ROAD

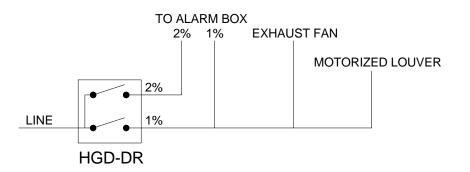
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P.O. BOX 505 Rochester, IN 46975 PHONE: 574.223.4934	DLS
FAX: 574.223.8779 www.whitleyman.com	Checked B
WHITLEY EAST 64 HESS ROAD	PC
LEOLA, PA 17540 PHONE: 717.656.2081 www.whitleyman.com	Re

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CABLE TRAY UNISTRUT	Serial No. 40044	Date: 5. 2019
	Quote No. ##	Scale: 070 070 070 070 070 070 070 070 070 07
	7582A Model No. Job No.	Page No.
	2019-101-SW	E3.3

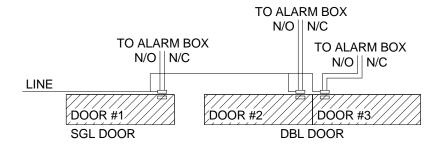
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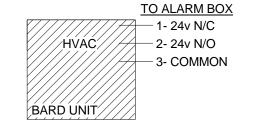
ALARM BOX DETAIL - 12"x12"x4" 1/2" = 1'-0"







	DOOR CONTACT SWITCH
(3)	3/8" = 1'-0"



BARD ALARM 3/8" = 1'-0"

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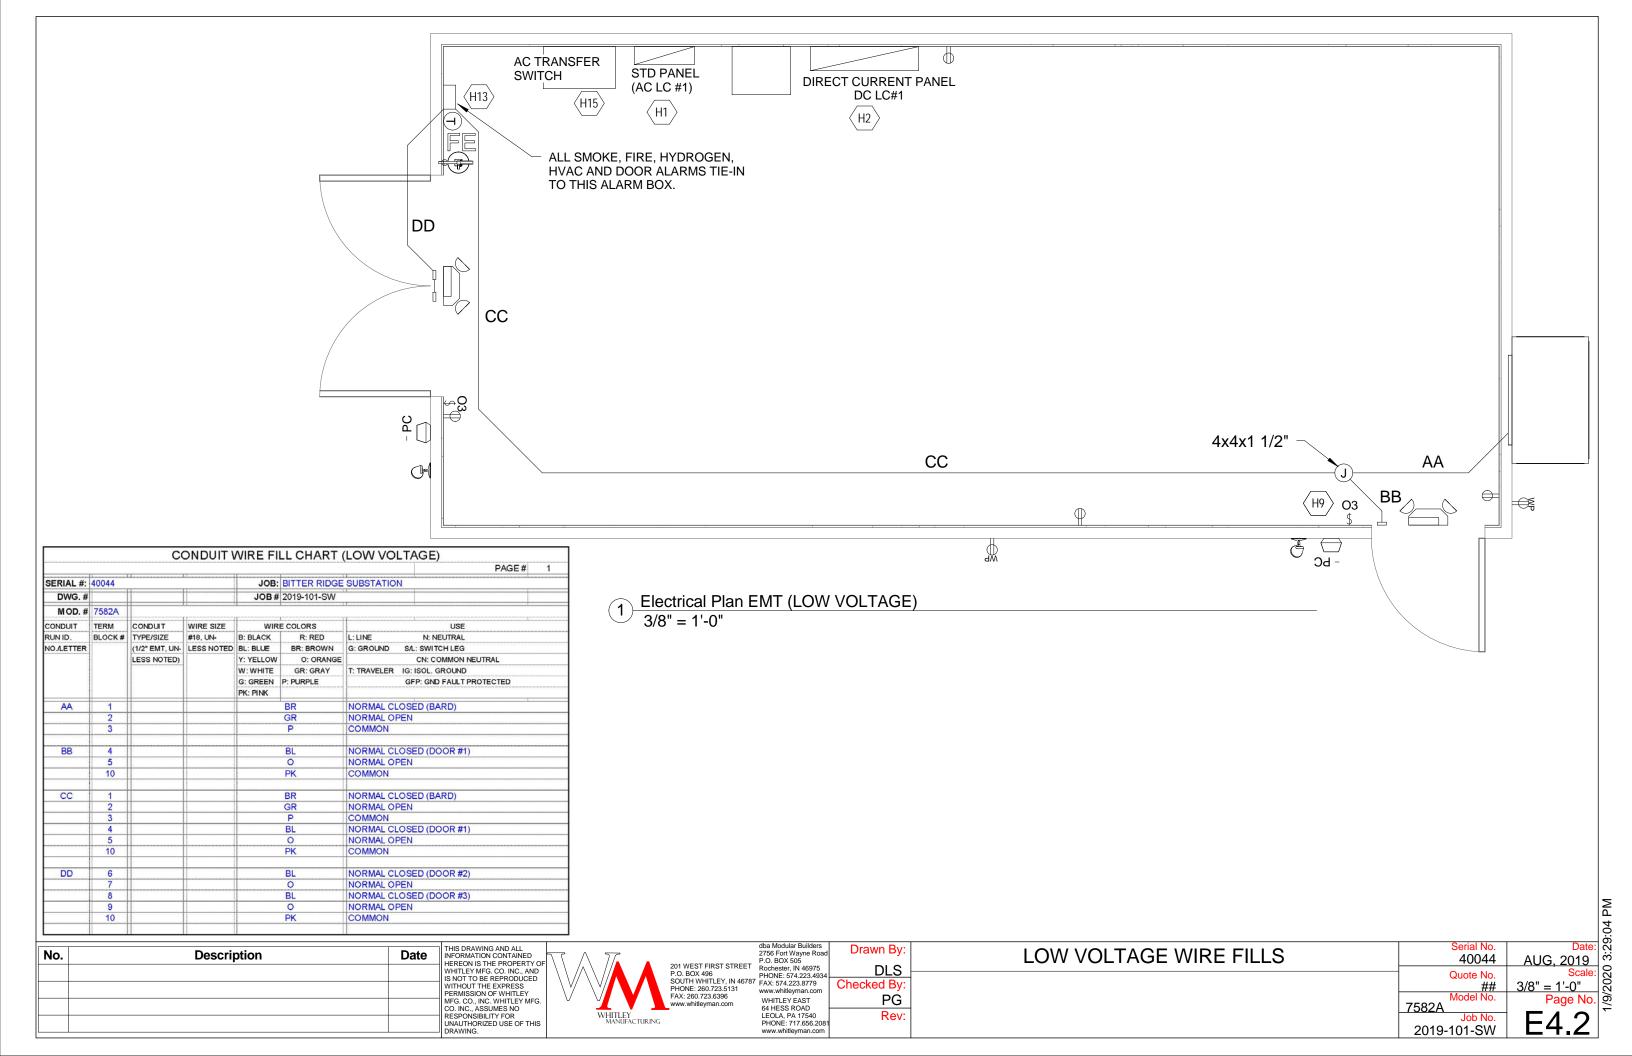


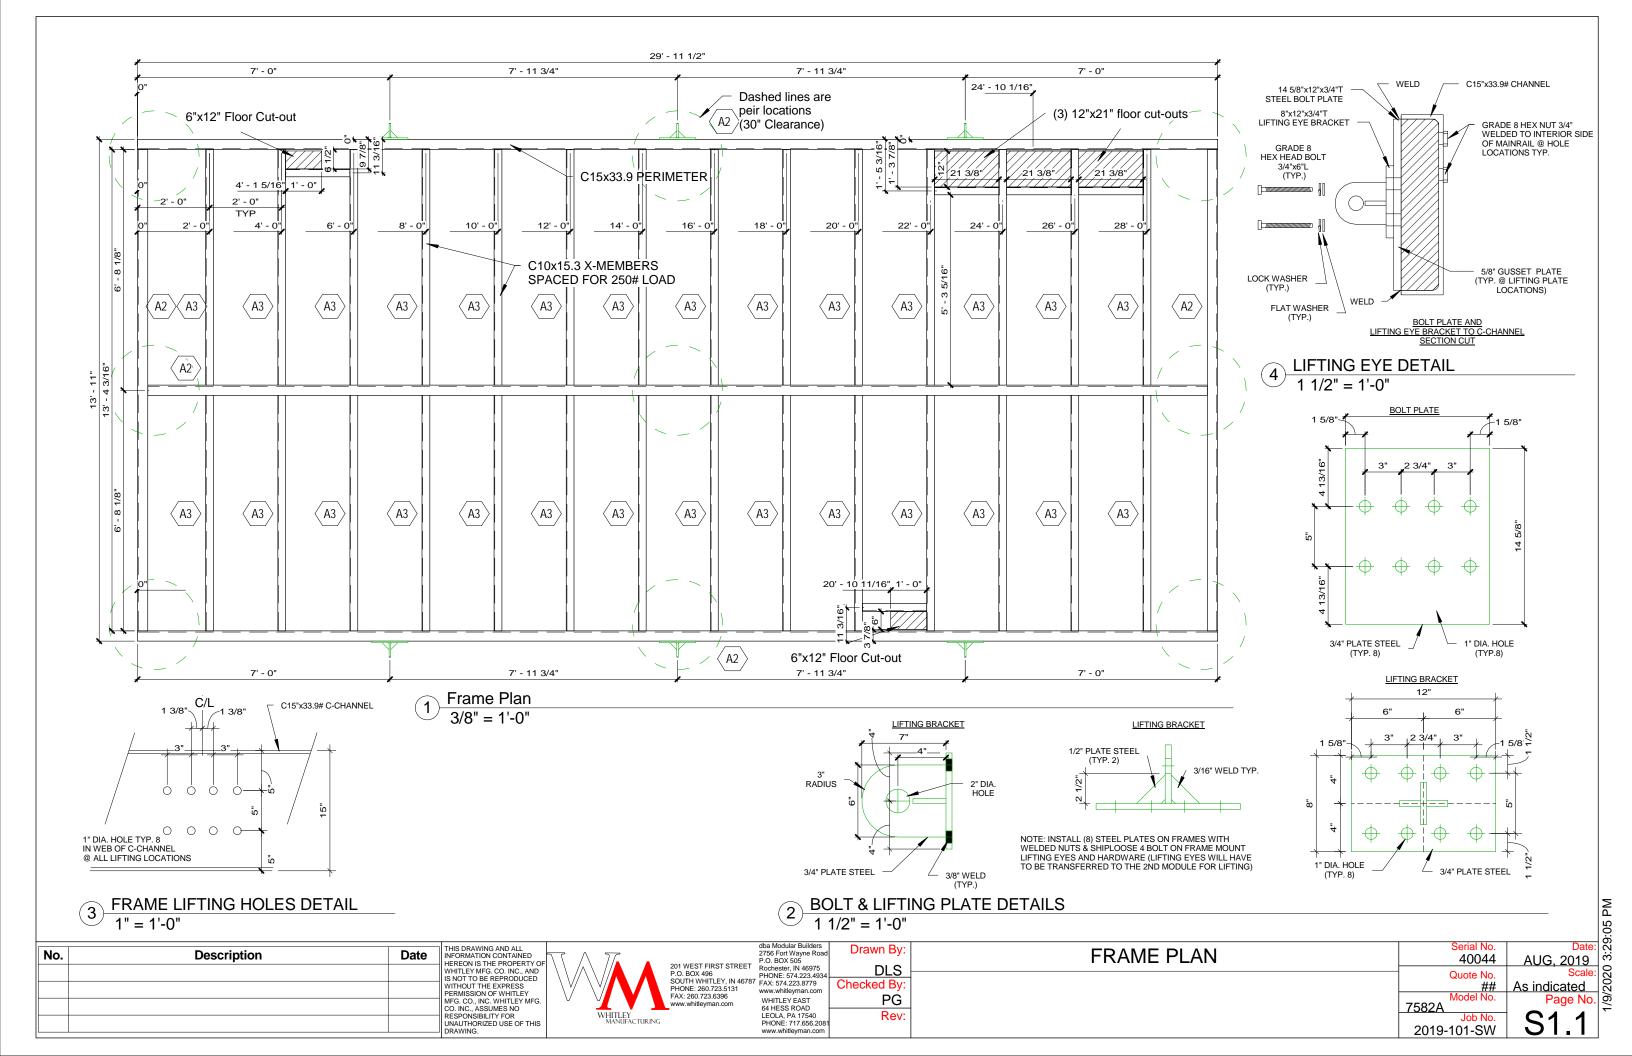
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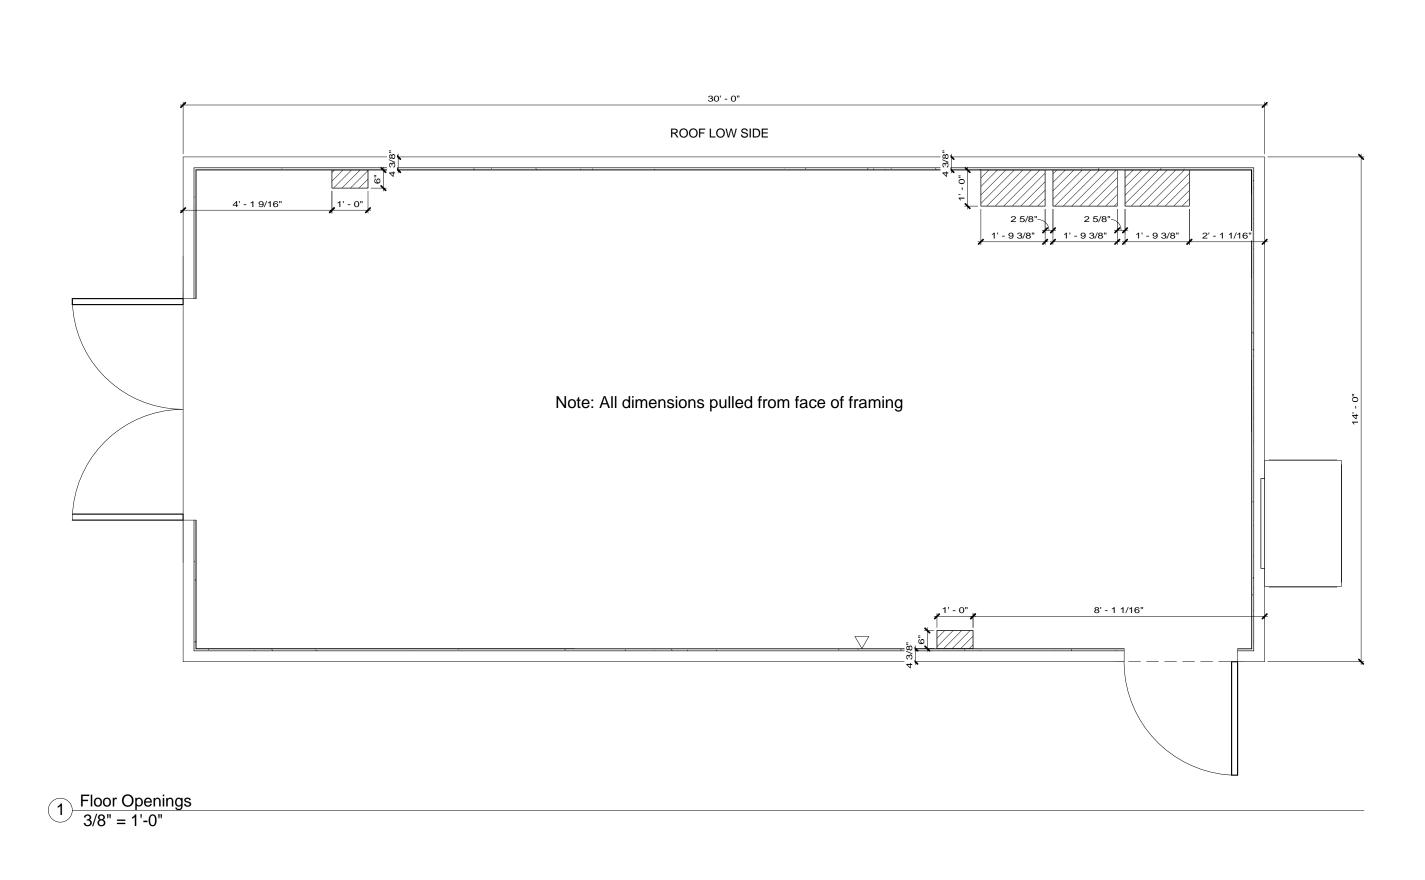
dba Modular Builders 2756 Fort Wayne Road	Drawn B
P.O. BOX 505	
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FAX: 574.223.8779	Checked B
www.whitleyman.com	D
WHITLEY EAST 64 HESS ROAD	-
LEOLA, PA 17540	Re
PHONE: 717.656.2081 www.whitleyman.com	
www.willucyllian.com	

AL ADM DOV DETAILO	Serial No.	Date:
ALARM BOX DETAILS	40044	AUG, 2019
	Quote No.	Scale:
	##	As indicated
	Model No.	Page No.
	7582A Job No.	
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	2019-101-SW	┗━ ̄• •

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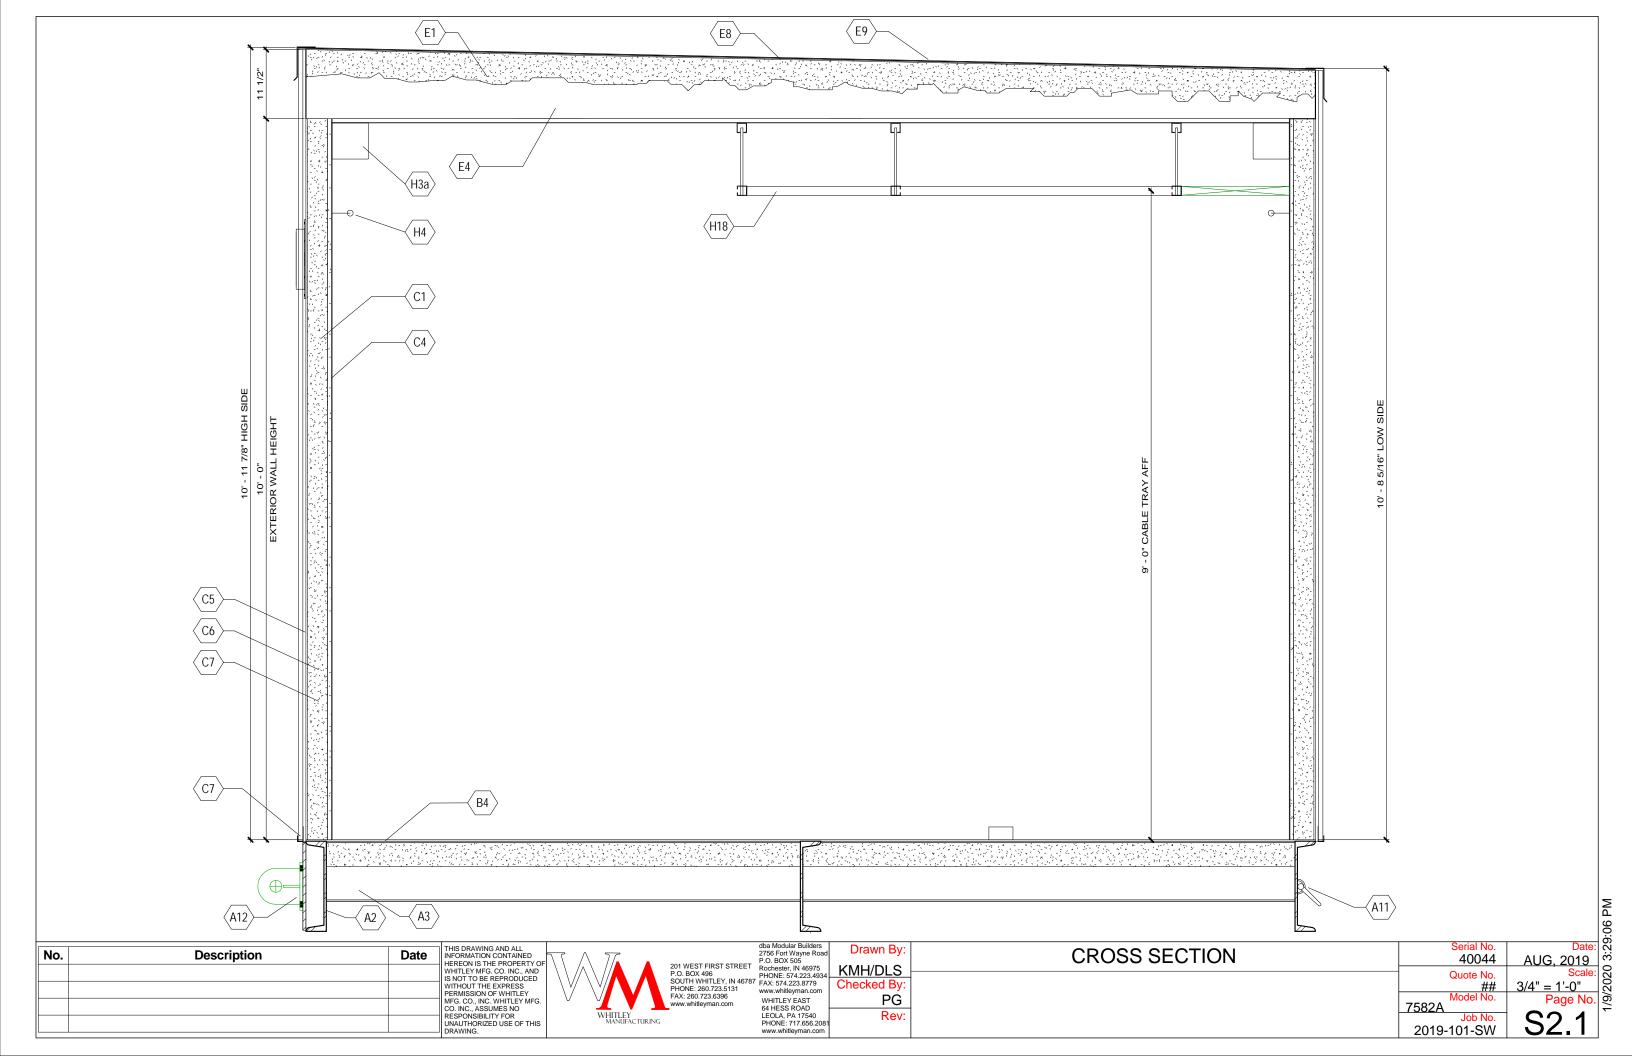


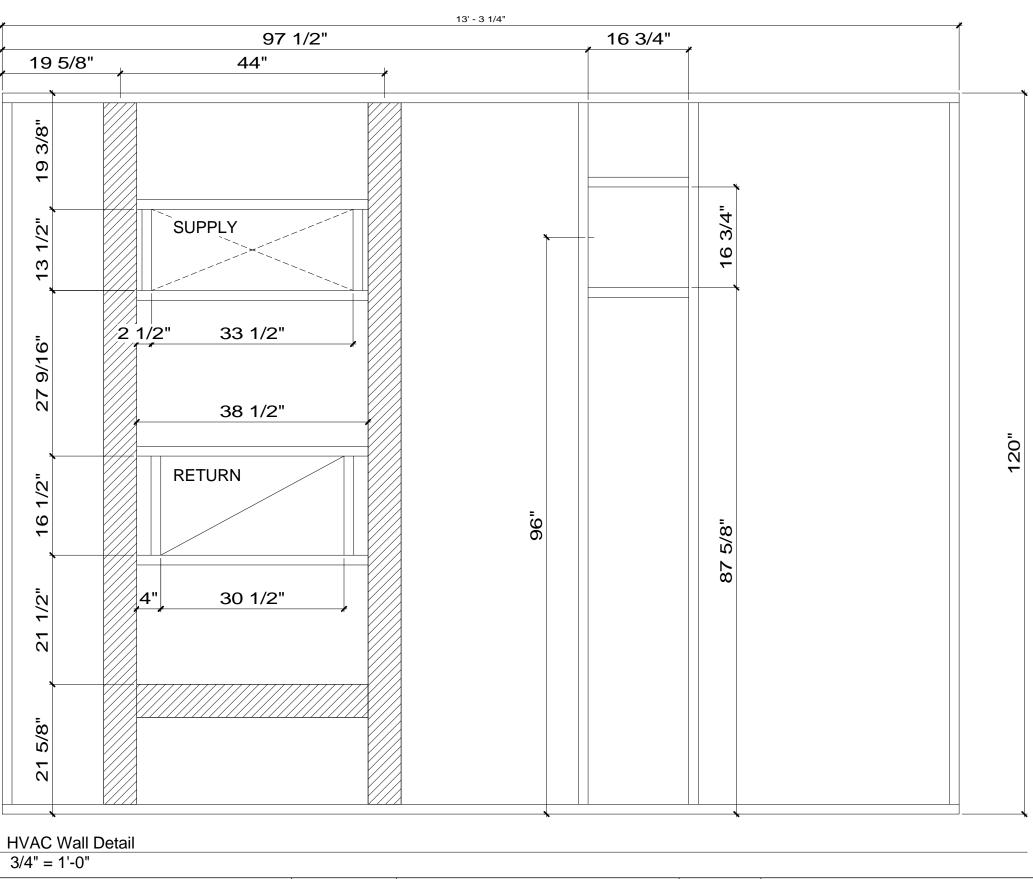


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			DRAWING			whitleyman.com		

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Serial No. 40044





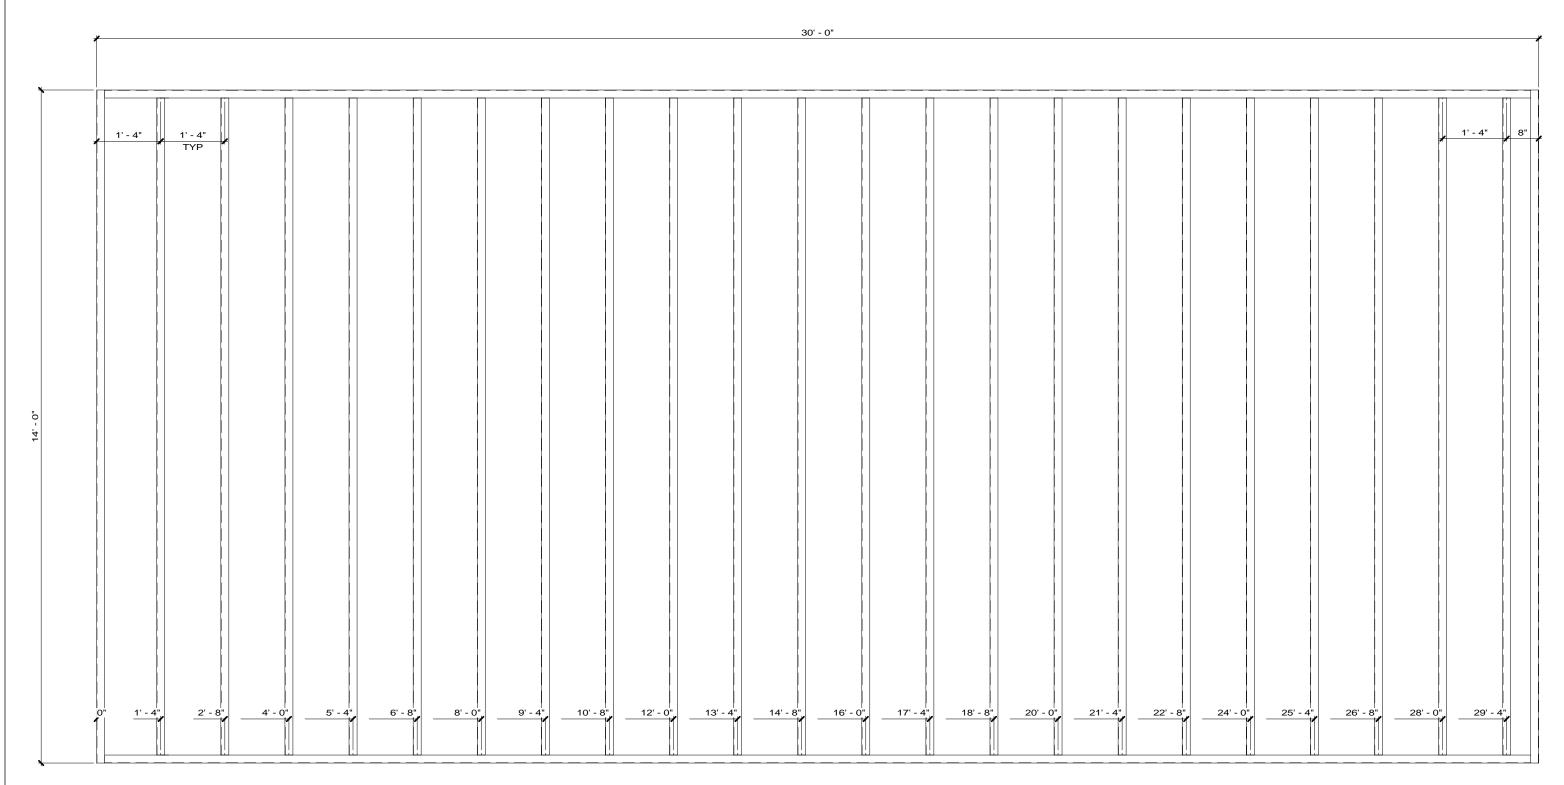
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PHONE: 260,723.6396
www.whitleyman.com
WHITLEY EAST
64 HESS ROAD
LEOLA, PA 17540
PHONE: 717.656.2081
www.whitleyman.com

Drawn By: DLS Checked By: PĞ Rev:

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			1
WALL DETAIL	Serial No.	Date:	3:29:06
WALL DETAIL	40044	AUG, 2019 Scale:	
	Quote No. ##	3/4" = 1'-0"	1/9/2020
	Model No. 7582A	Page No.	6/
	Job No.	C22	
	2019-101-SW	<u> </u>]



First Floor Roof Framing Plan
1/2" = 1'-0"

No.	Description	Date

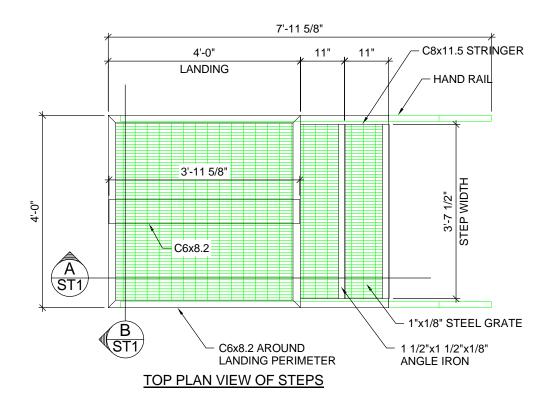
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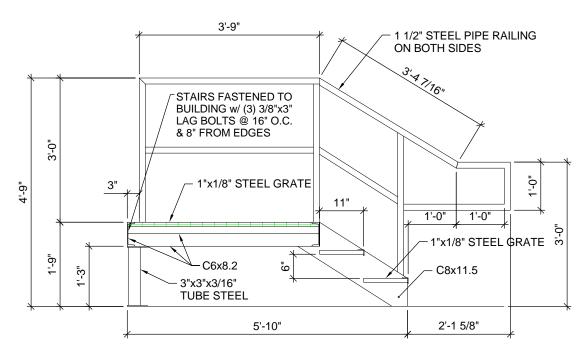
ΕT	dba Modular Builders 2756 Fort Wayne Road P.O. BOX 505 Rochester, IN 46975 PHONE: 574.223.4934	
787	FAX: 574.223.8779 www.whitleyman.com WHITLEY EAST	
	64 HESS ROAD LEOLA, PA 17540 PHONE: 717.656.2081 www.whitleyman.com	

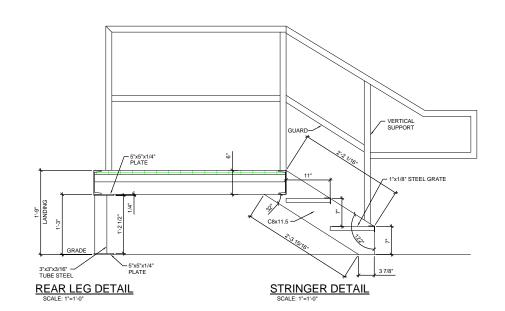
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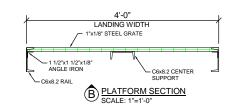
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	Quote No. ##	Scale: 1/2" = 1'-0" Page No.	2020
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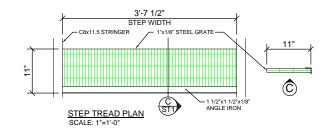


STEP PLAN SCALE: 1/2"=1'-0"











1 Stair Details
1/2" = 1'-0"

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